05 - CIVIL INDEX OF DRAWINGS


DRAWING NUMBER	DRAWING TITLE	DRAWING NUMBER	DRAWING TITLE
C-001	INDEX OF DRAWINGS	C-021	CIVIL DETAILS - 1
C-002	EROSION AND SEDIMENT POLLUTION CONTROL - 1	C-022	CIVIL DETAILS - 2
C-003	EROSION AND SEDIMENT POLLUTION CONTROL - 2	C-023	CIVIL DETAILS - 3
C-004	EROSION AND SEDIMENT POLLUTION CONTROL - 3	C-024	WATER MAIN DETAILS - 1
C-005	SITE PLAN - 1	C-025	WATER MAIN DETAILS - 2
C-006	SITE PLAN - 2	C-026	SANITARY SEWER DETAILS - 1
C-007	SITE PLAN - 3	C-027	SANITARY SEWER DETAILS - 2
C-008	DRAINAGE PLAN	C-028	SANITARY SEWER DETAILS - 3
C-009	DRAINAGE BASIN DETAIL - 1	C-029	SANITARY SEWER DETAILS - 4
C-010	DRAINAGE BASIN DETAIL - 2	CT-001	MOTOR FUEL ISLAND PLAN
C-011	GRADING PLAN	CT-002	MOTOR FUEL TANK DETAILS
C-012	GEOMETRY PLAN - 1	CT-003	MOTOR FUEL ISLAND DETAILS
C-013	GEOMETRY PLAN - 2	CT-004	OIL-WATER SEPARATOR
C-014	GEOMETRY PLAN - 3	CT-005	TANK MONITORING SYSTEM SITE PLAN
C-015	UTILITY PLAN - 1	CT-006	MOTOR FUEL ISLAND CONDUIT
C-016	UTILITY PLAN - 2	CT-007	TANK MONITORING SYSTEM DETAILS
C-017	UTILITY PLAN - 3	CT-008	MOTOR FUEL ISLAND ELECTRICAL DETAILS
C-018	PAVEMENT MARKING PLAN - 1		
C-019	PAVEMENT MARKING PLAN - 2		
C-020	PAVEMENT MARKING PLAN - 3		




-	-	-	-	THE INFORMATION, INCLUDING ESTIMATED
-	-	-	-	QUANTITIES OF WORK, SHOWN ON THESE SHEETS IS BASED ON LIMITED
-	-	-	-	INVESTIGATIONS BY THE STATE AND IS IN NO WAY WARRANTED TO INDICATE
-	-	-	-	THE CONDITIONS OF ACTUAL QUANTITIES
-	-	-	-	OF WORK WHICH WILL BE REQUIRED.
-	-	-	-	
REV.	DATE	REVISION DESCRIPTION	SHEET NO.	Plotted Date: 10/12/2014

HECKED BY:

AGB

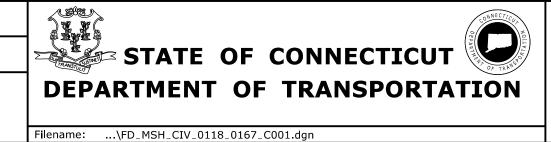


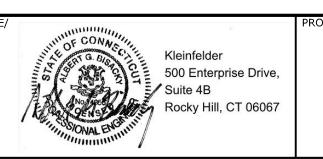


REPAIR FACILITY

ROCKY HILL	PROJECT NO. 118-16
	DRAWING NO. C-001
INDEX OF DRAWINGS	SHEET NO. 05.01

- ALL EROSION AND SEDIMENT CONTROL MEASURES SHALL MEET OR EXCEED THE REQUIREMENTS OF THE D.E.P. 2002 E&S GUIDELINES AND THE 2004 STORMWATER QUALITY MANUAL.
- REMOVE ALL TEMPORARY SEDIMENTATION CONTROL SYSTEMS ONCE ALL WORK HAS BEEN COMPLETED AND SITE HAS REACHED FINAL STABILIZATION.

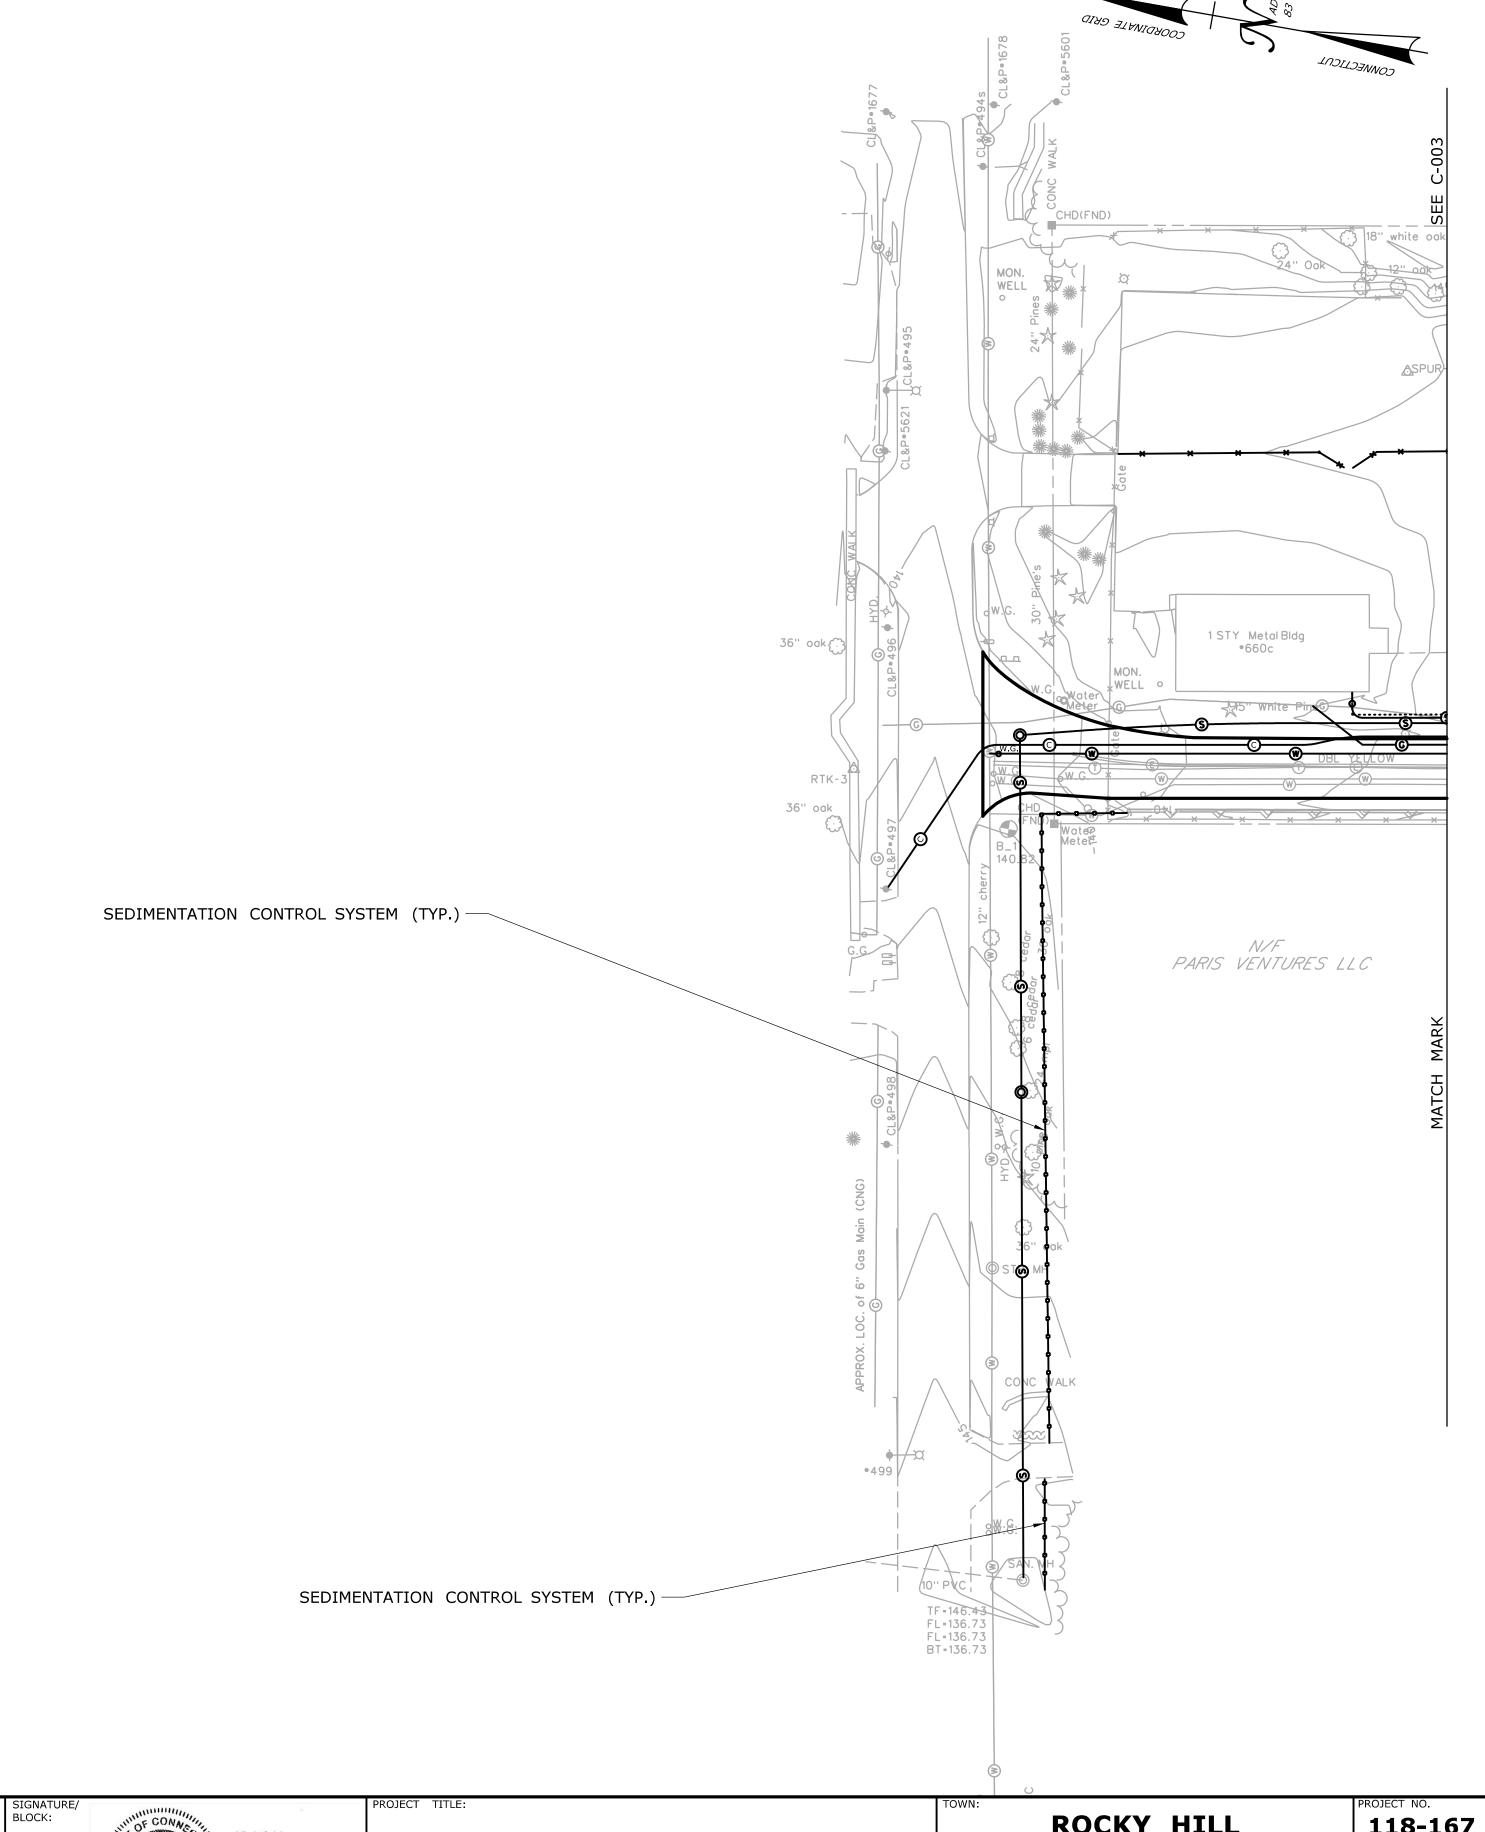

-	-	-	-	THE INFORMATION, INCLUDING ESTIMATE
-	-	-	-	QUANTITIES OF WORK, SHOWN ON THES SHEETS IS BASED ON LIMITED
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-	-	-	-	THE CONDITIONS OF ACTUAL QUANTITIE
-	-	-	-	OF WORK WHICH WILL BE REQUIRED.
-	-	-	-	
REV.	DATE	REVISION DESCRIPTION	SHEET NO.	Plotted Date: 10/10/2014

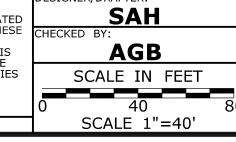



	STATE OF CONNECTICUT	CONNECTION NOT TRANS
. 30	DEPARTMENT OF TRANSPORTA	TION
	Filename: \FD MSH SED 0118 0167 C002 dan	<u> </u>



REPAIR	FACILITY

RAWING TITLE: EROSION AND SEDIMENT	DRAWING NO. C-002 SHEET NO.
POLLUTION CONTROL - 1	05.02

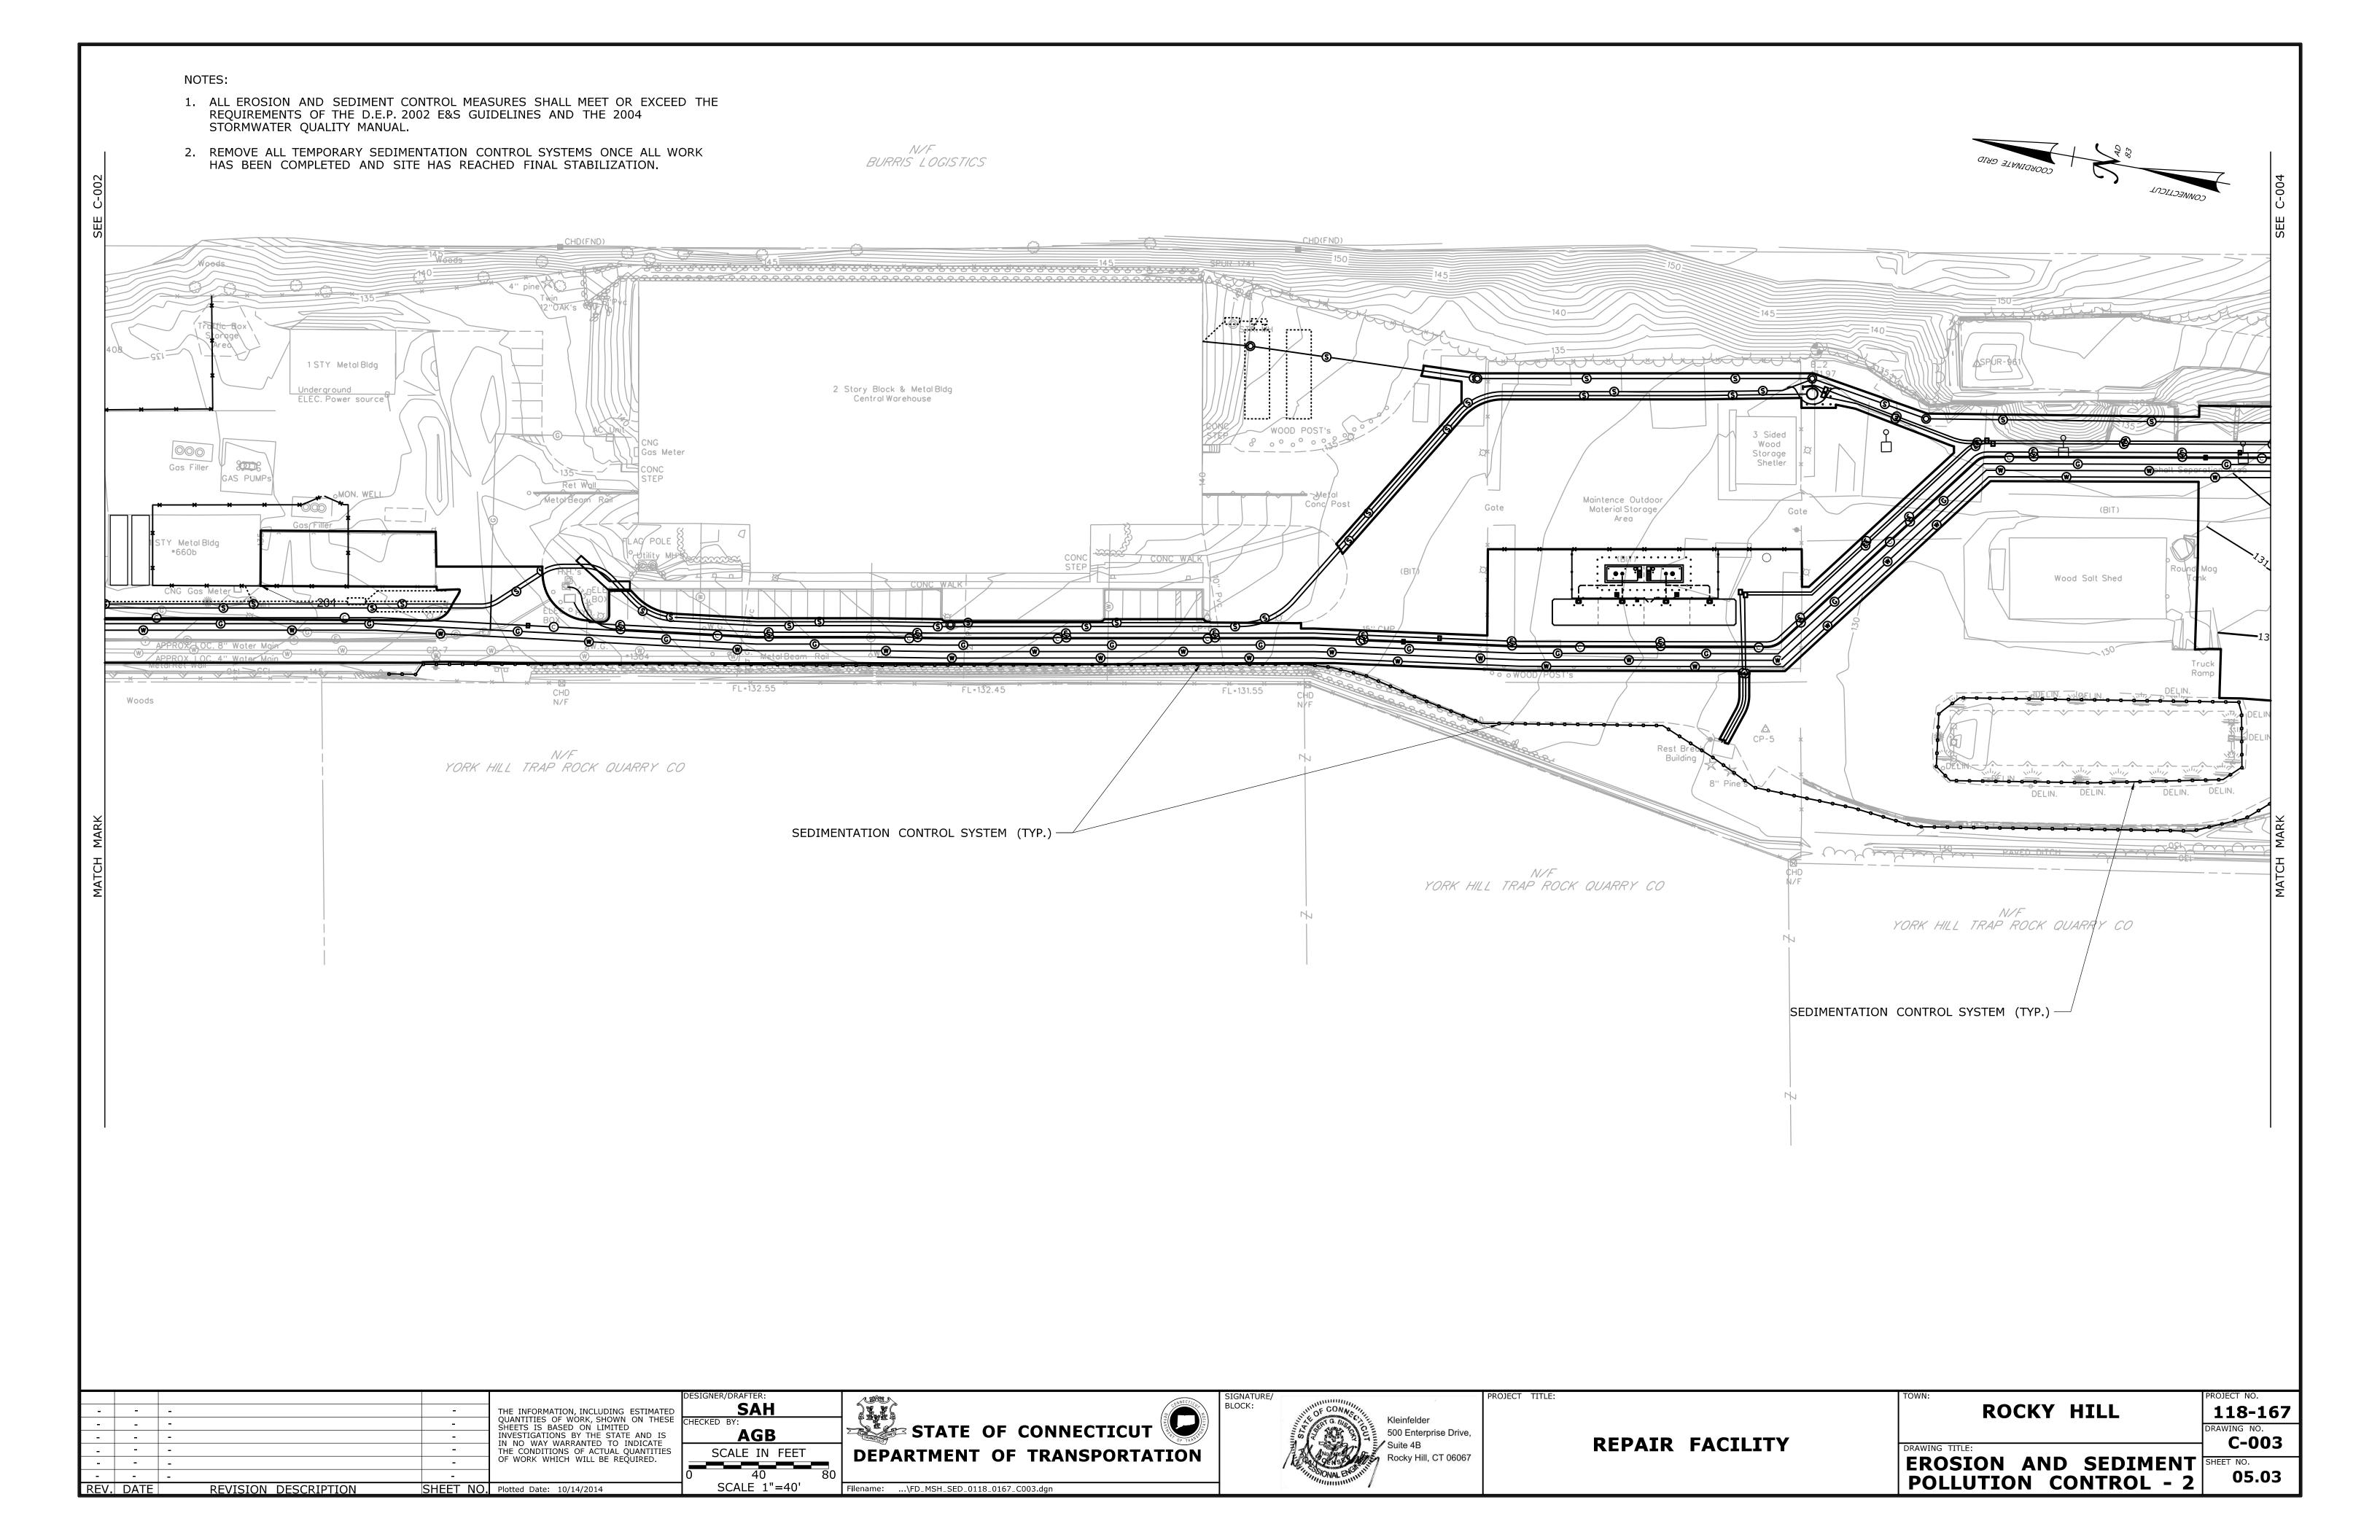

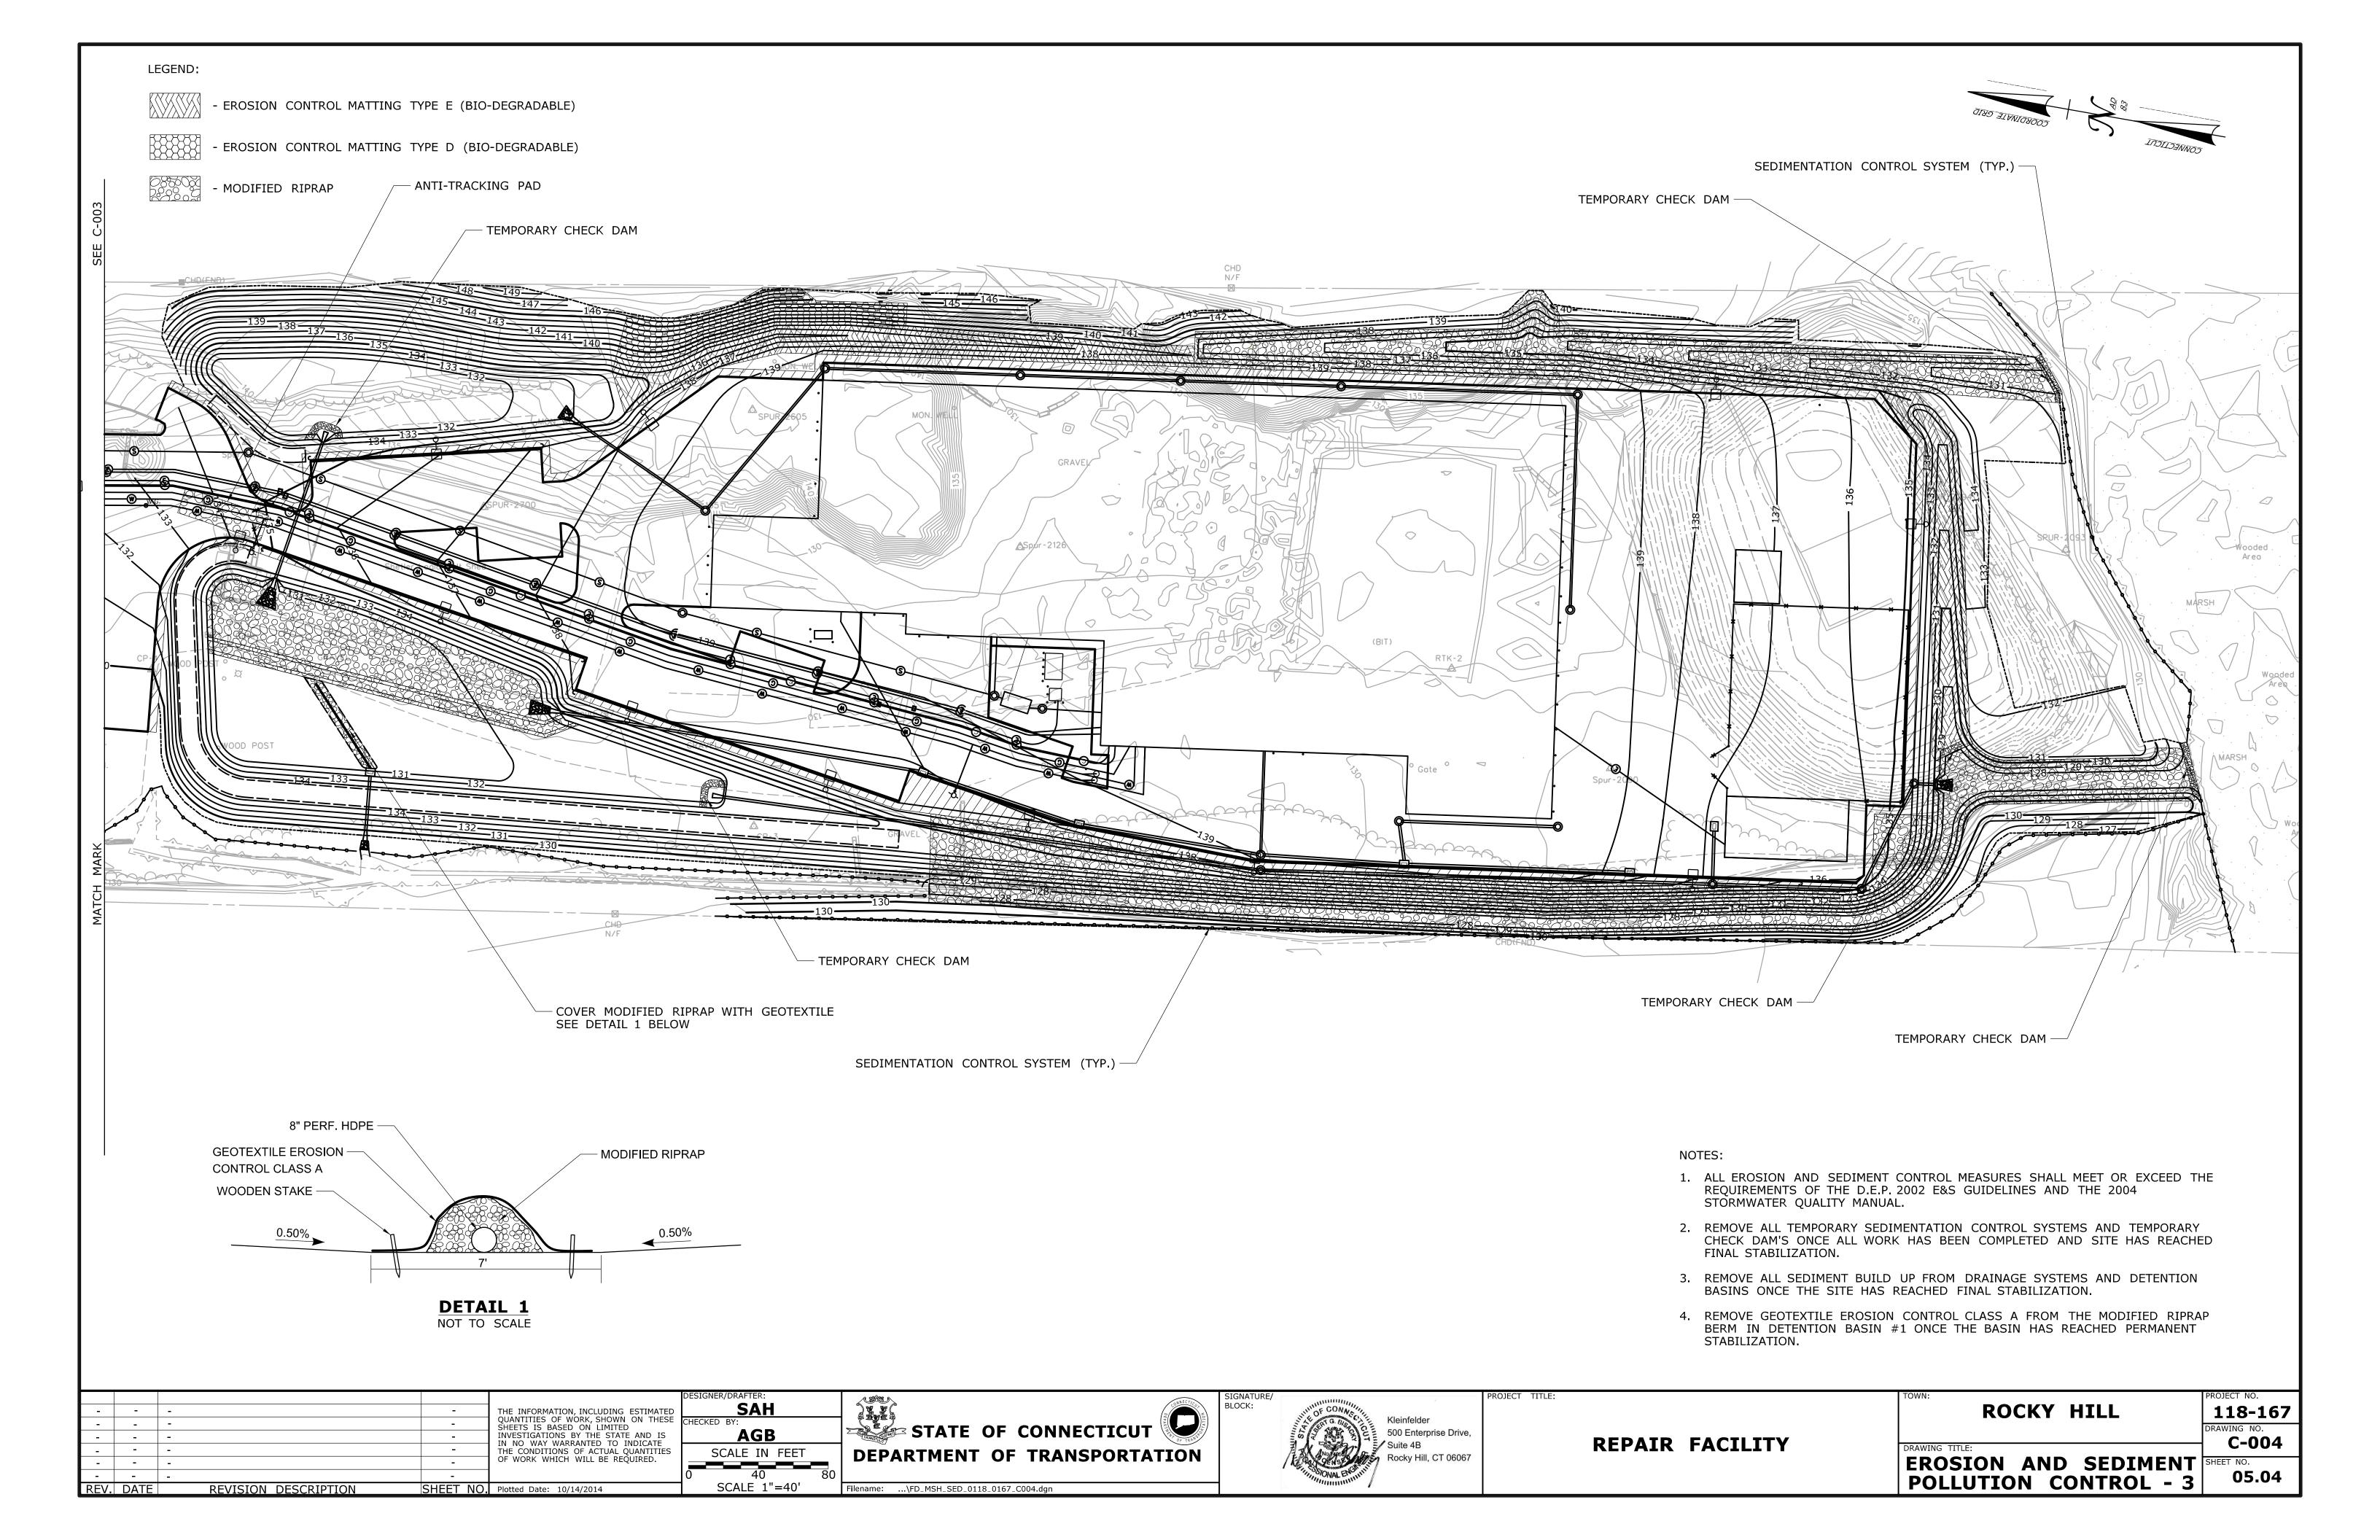


- CONTACT "CALL BEFORE YOU DIG" AT 1-800-922-4455 AT LEAST TWO FULL BUSINESS DAYS BEFORE BEGINNING ANY EXCAVATION.
- THE CONTRACTOR IS RESPONSIBLE FOR PROTECTING EXISTING UTILITIES AND SURVEY MARKERS WITHIN THE PROJECT LIMITS. REFER TO FORM 816, SECTION 1.07.09.
- 3. ESTABLISH TURF IN ALL UNPAVED DISTURBED AREAS.

LEGEND

FULL-DEPTH BITUMINOUS CONCRETE PAVEMENT REFER TO DRAWING C-022

2" MILL AND OVERLAY OF BITUMINOUS CONCRETE PAVEMENT REFER TO DRAWING C-022

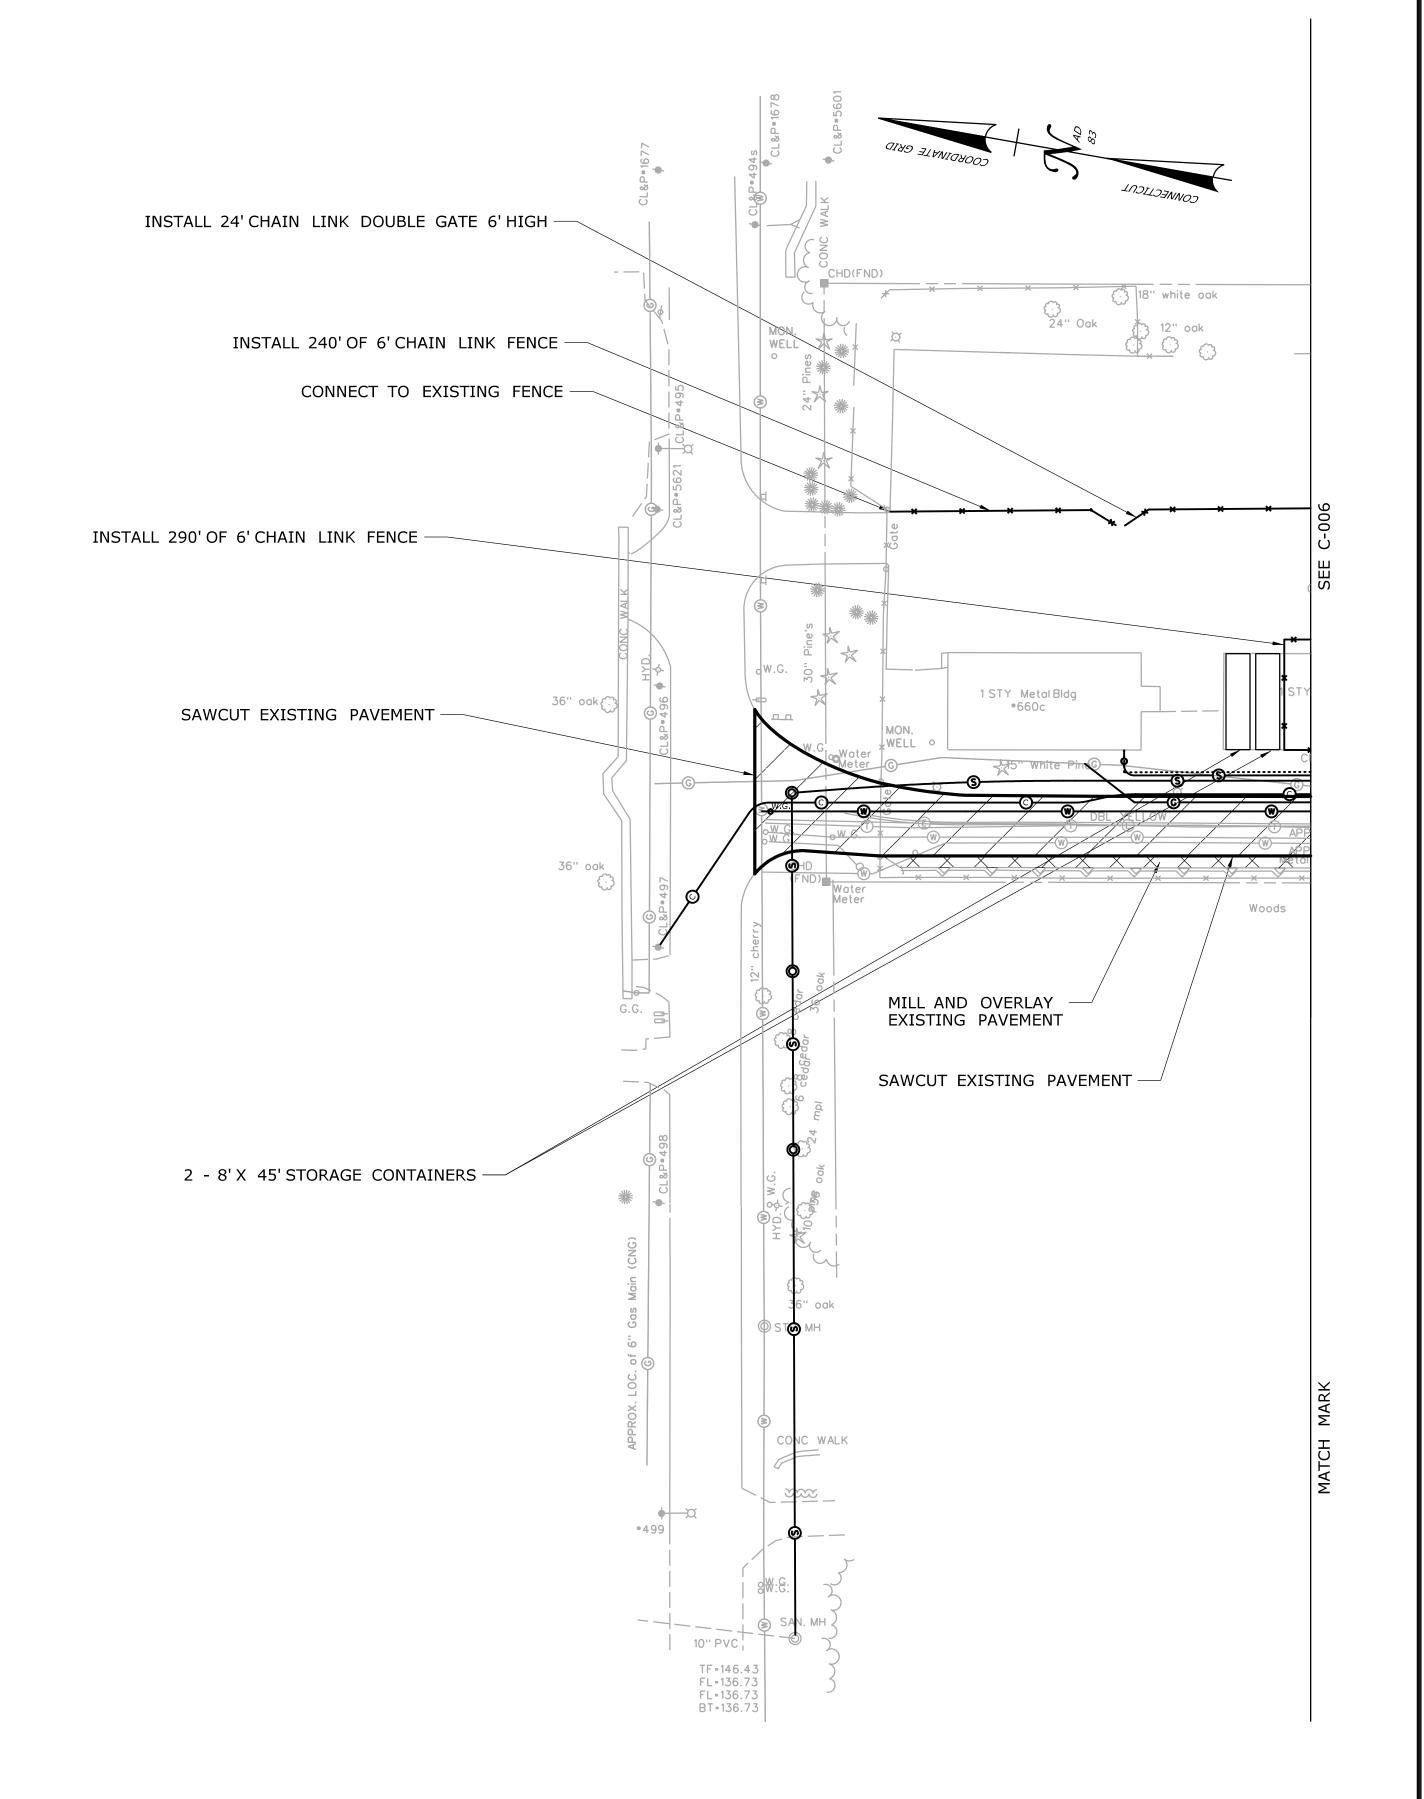


_	-	-	_	THE INFORMATION, INCLUDING ESTIMAT
-	-	-	-	QUANTITIES OF WORK, SHOWN ON THE SHEETS IS BASED ON LIMITED INVESTIGATIONS BY THE STATE AND IN NO WAY WARRANTED TO INDICAT THE CONDITIONS OF ACTUAL QUANTIT OF WORK WHICH WILL BE REQUIRED.
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SHEET NO. Plotted Date: 10/12/2014


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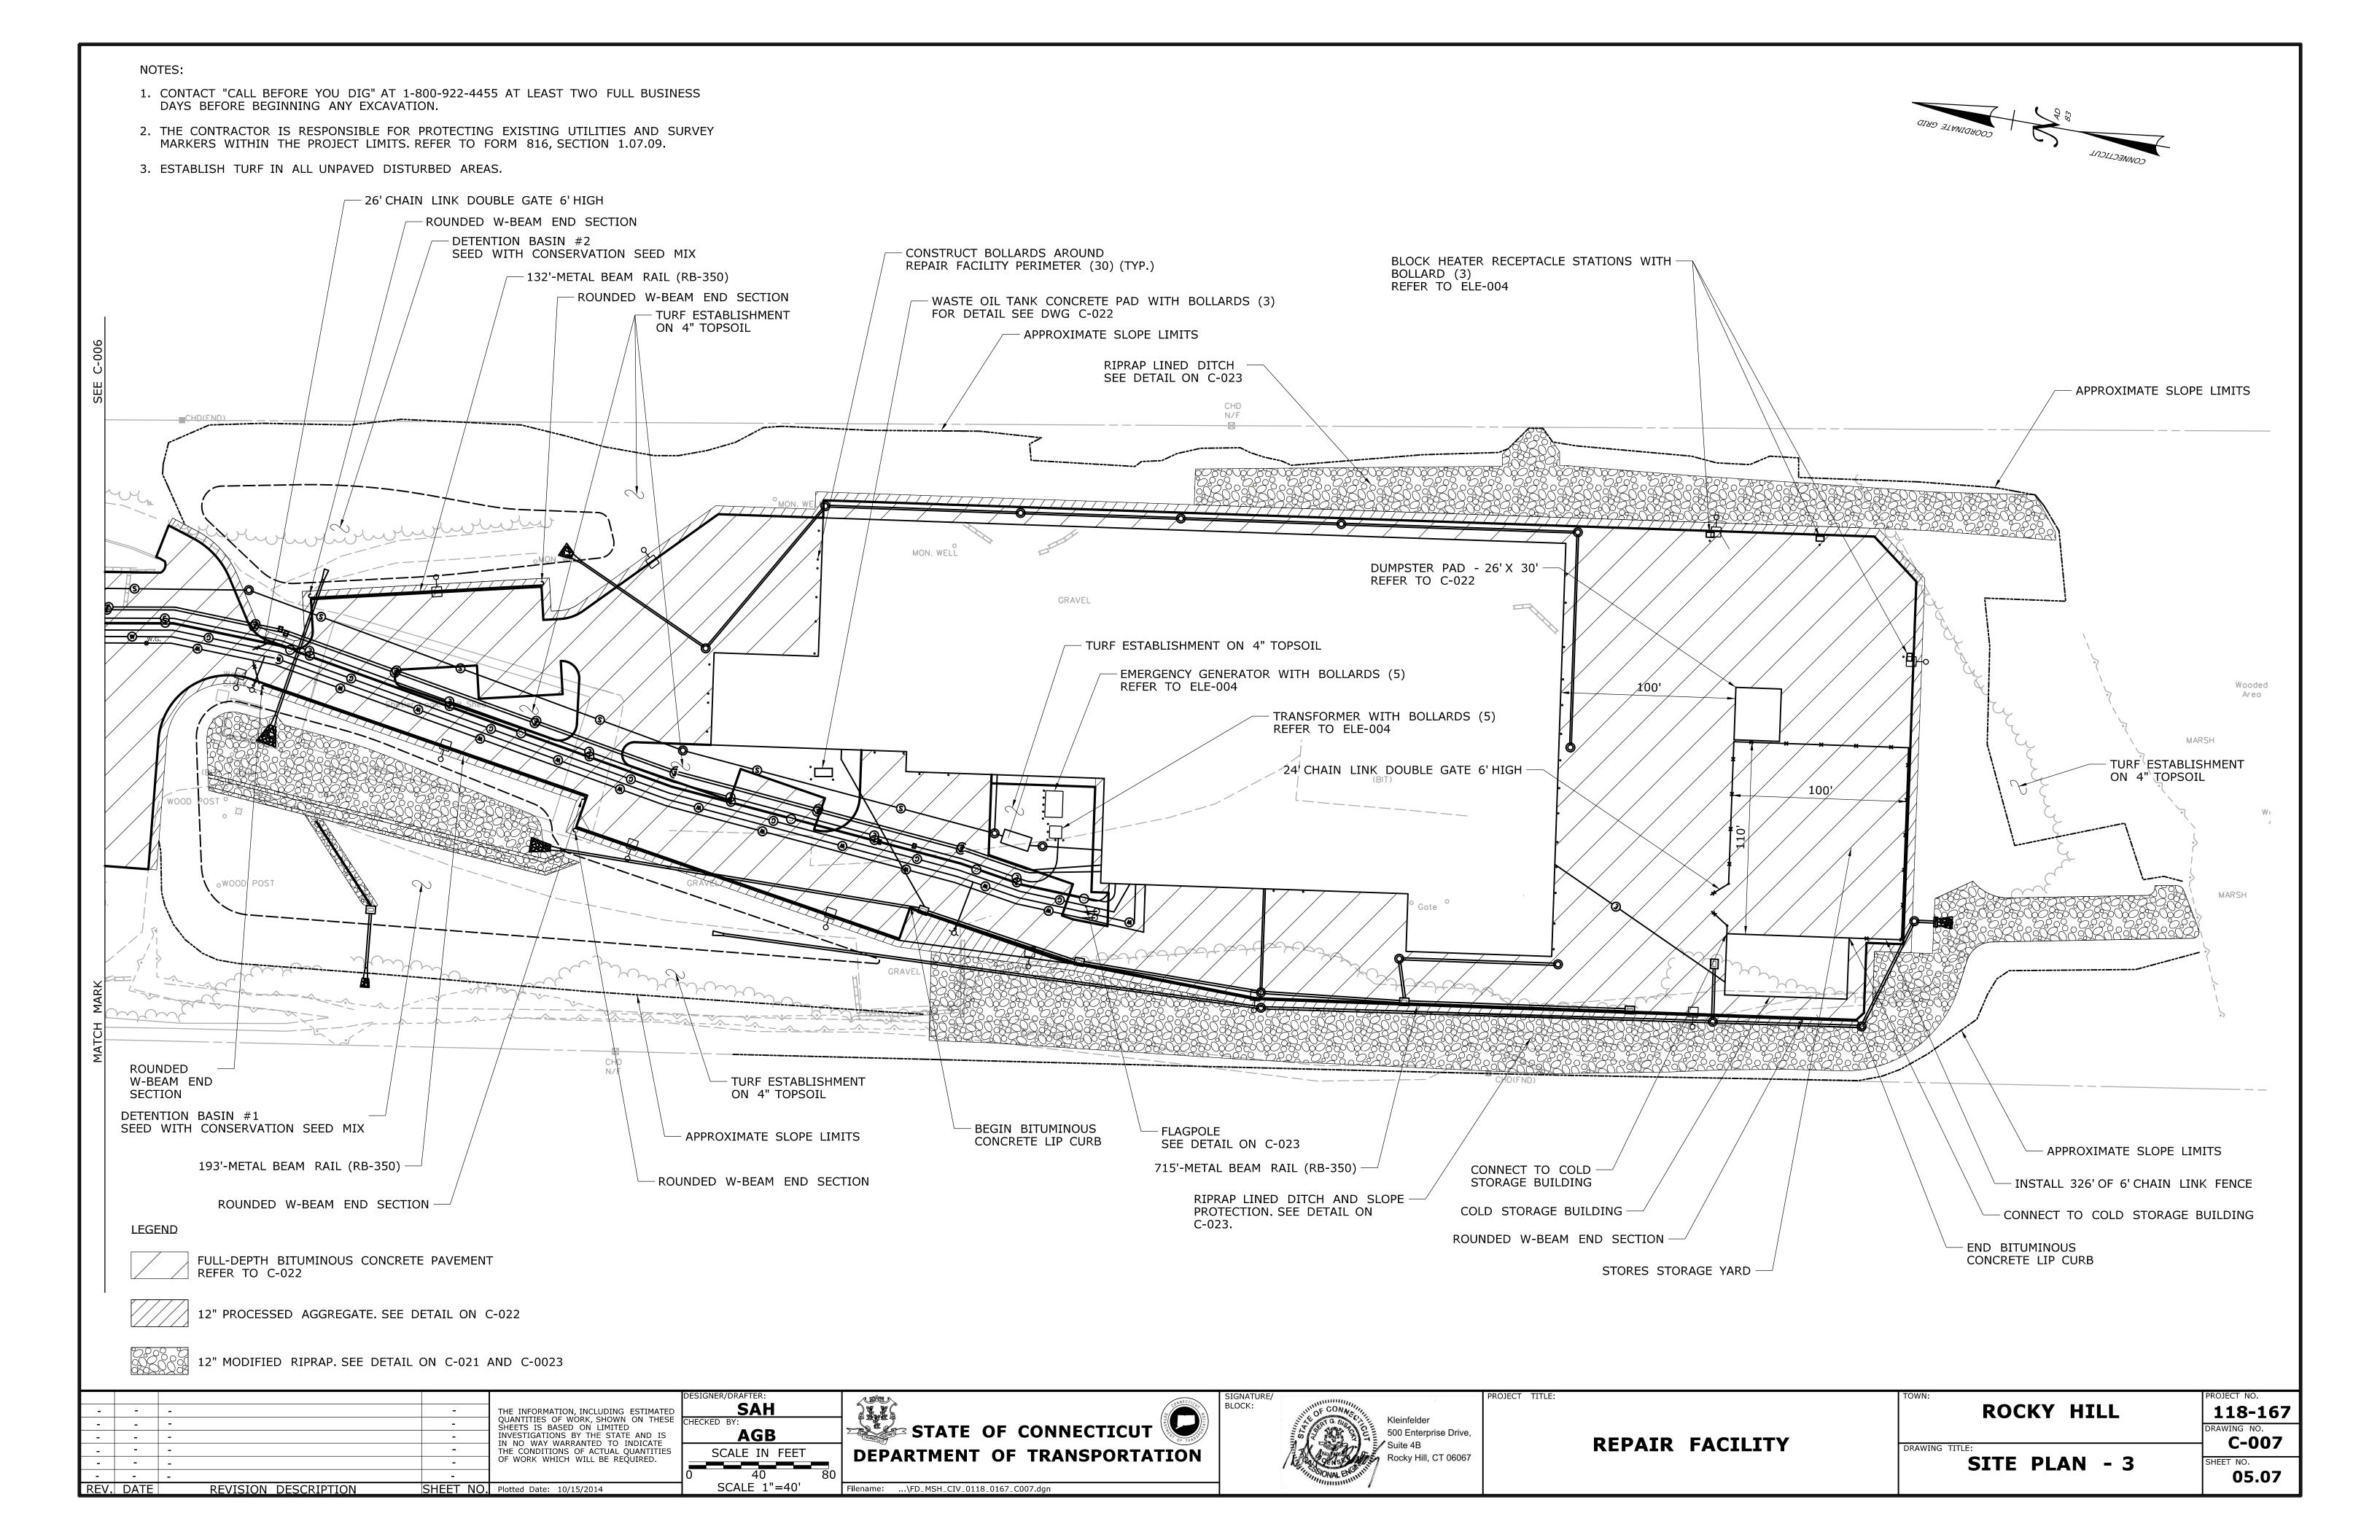
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SCALE 1"=40'	Filename:\FD_MSH_CIV_0118_0167_C005.dgn





REPAIR	FACILITY

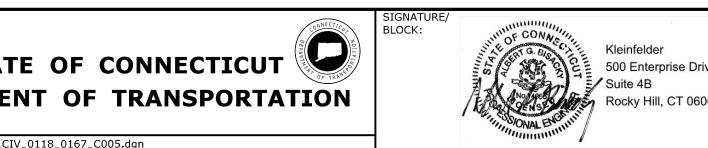
ROCKY HILL	PROJECT NO. 118-167
DRAWING TITLE:	C-005
SITE PLAN - 1	SHEET NO. 05.05




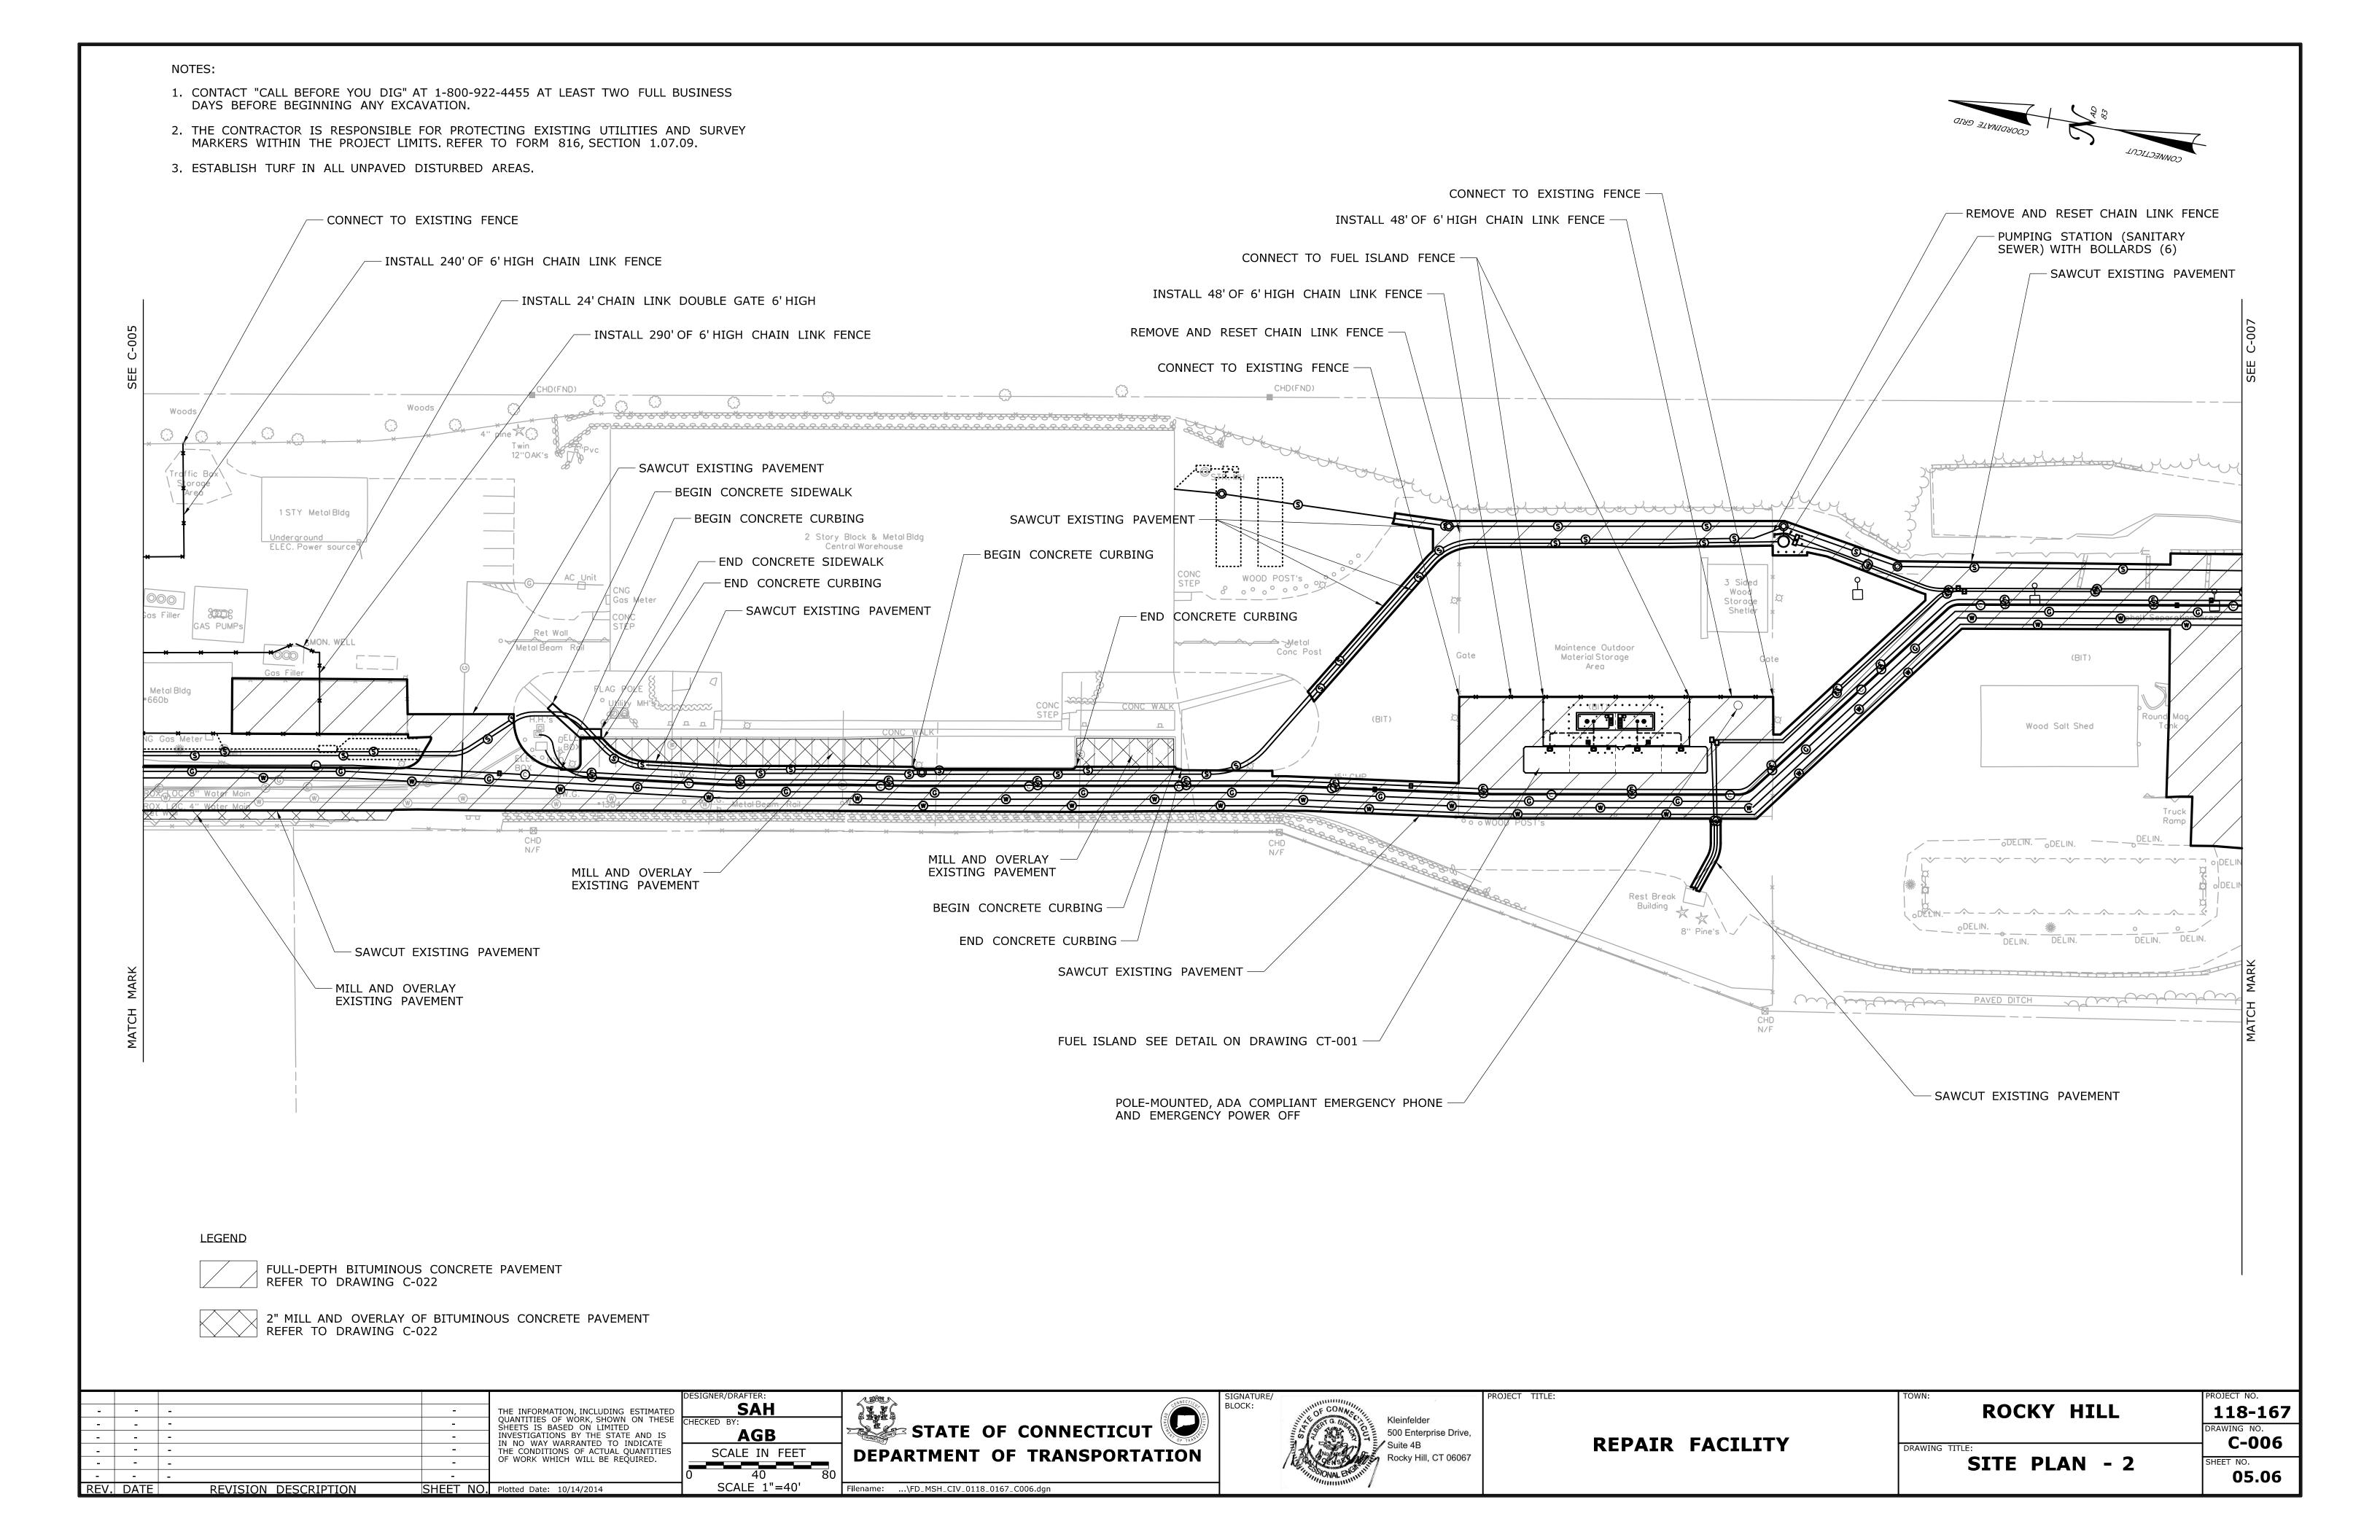


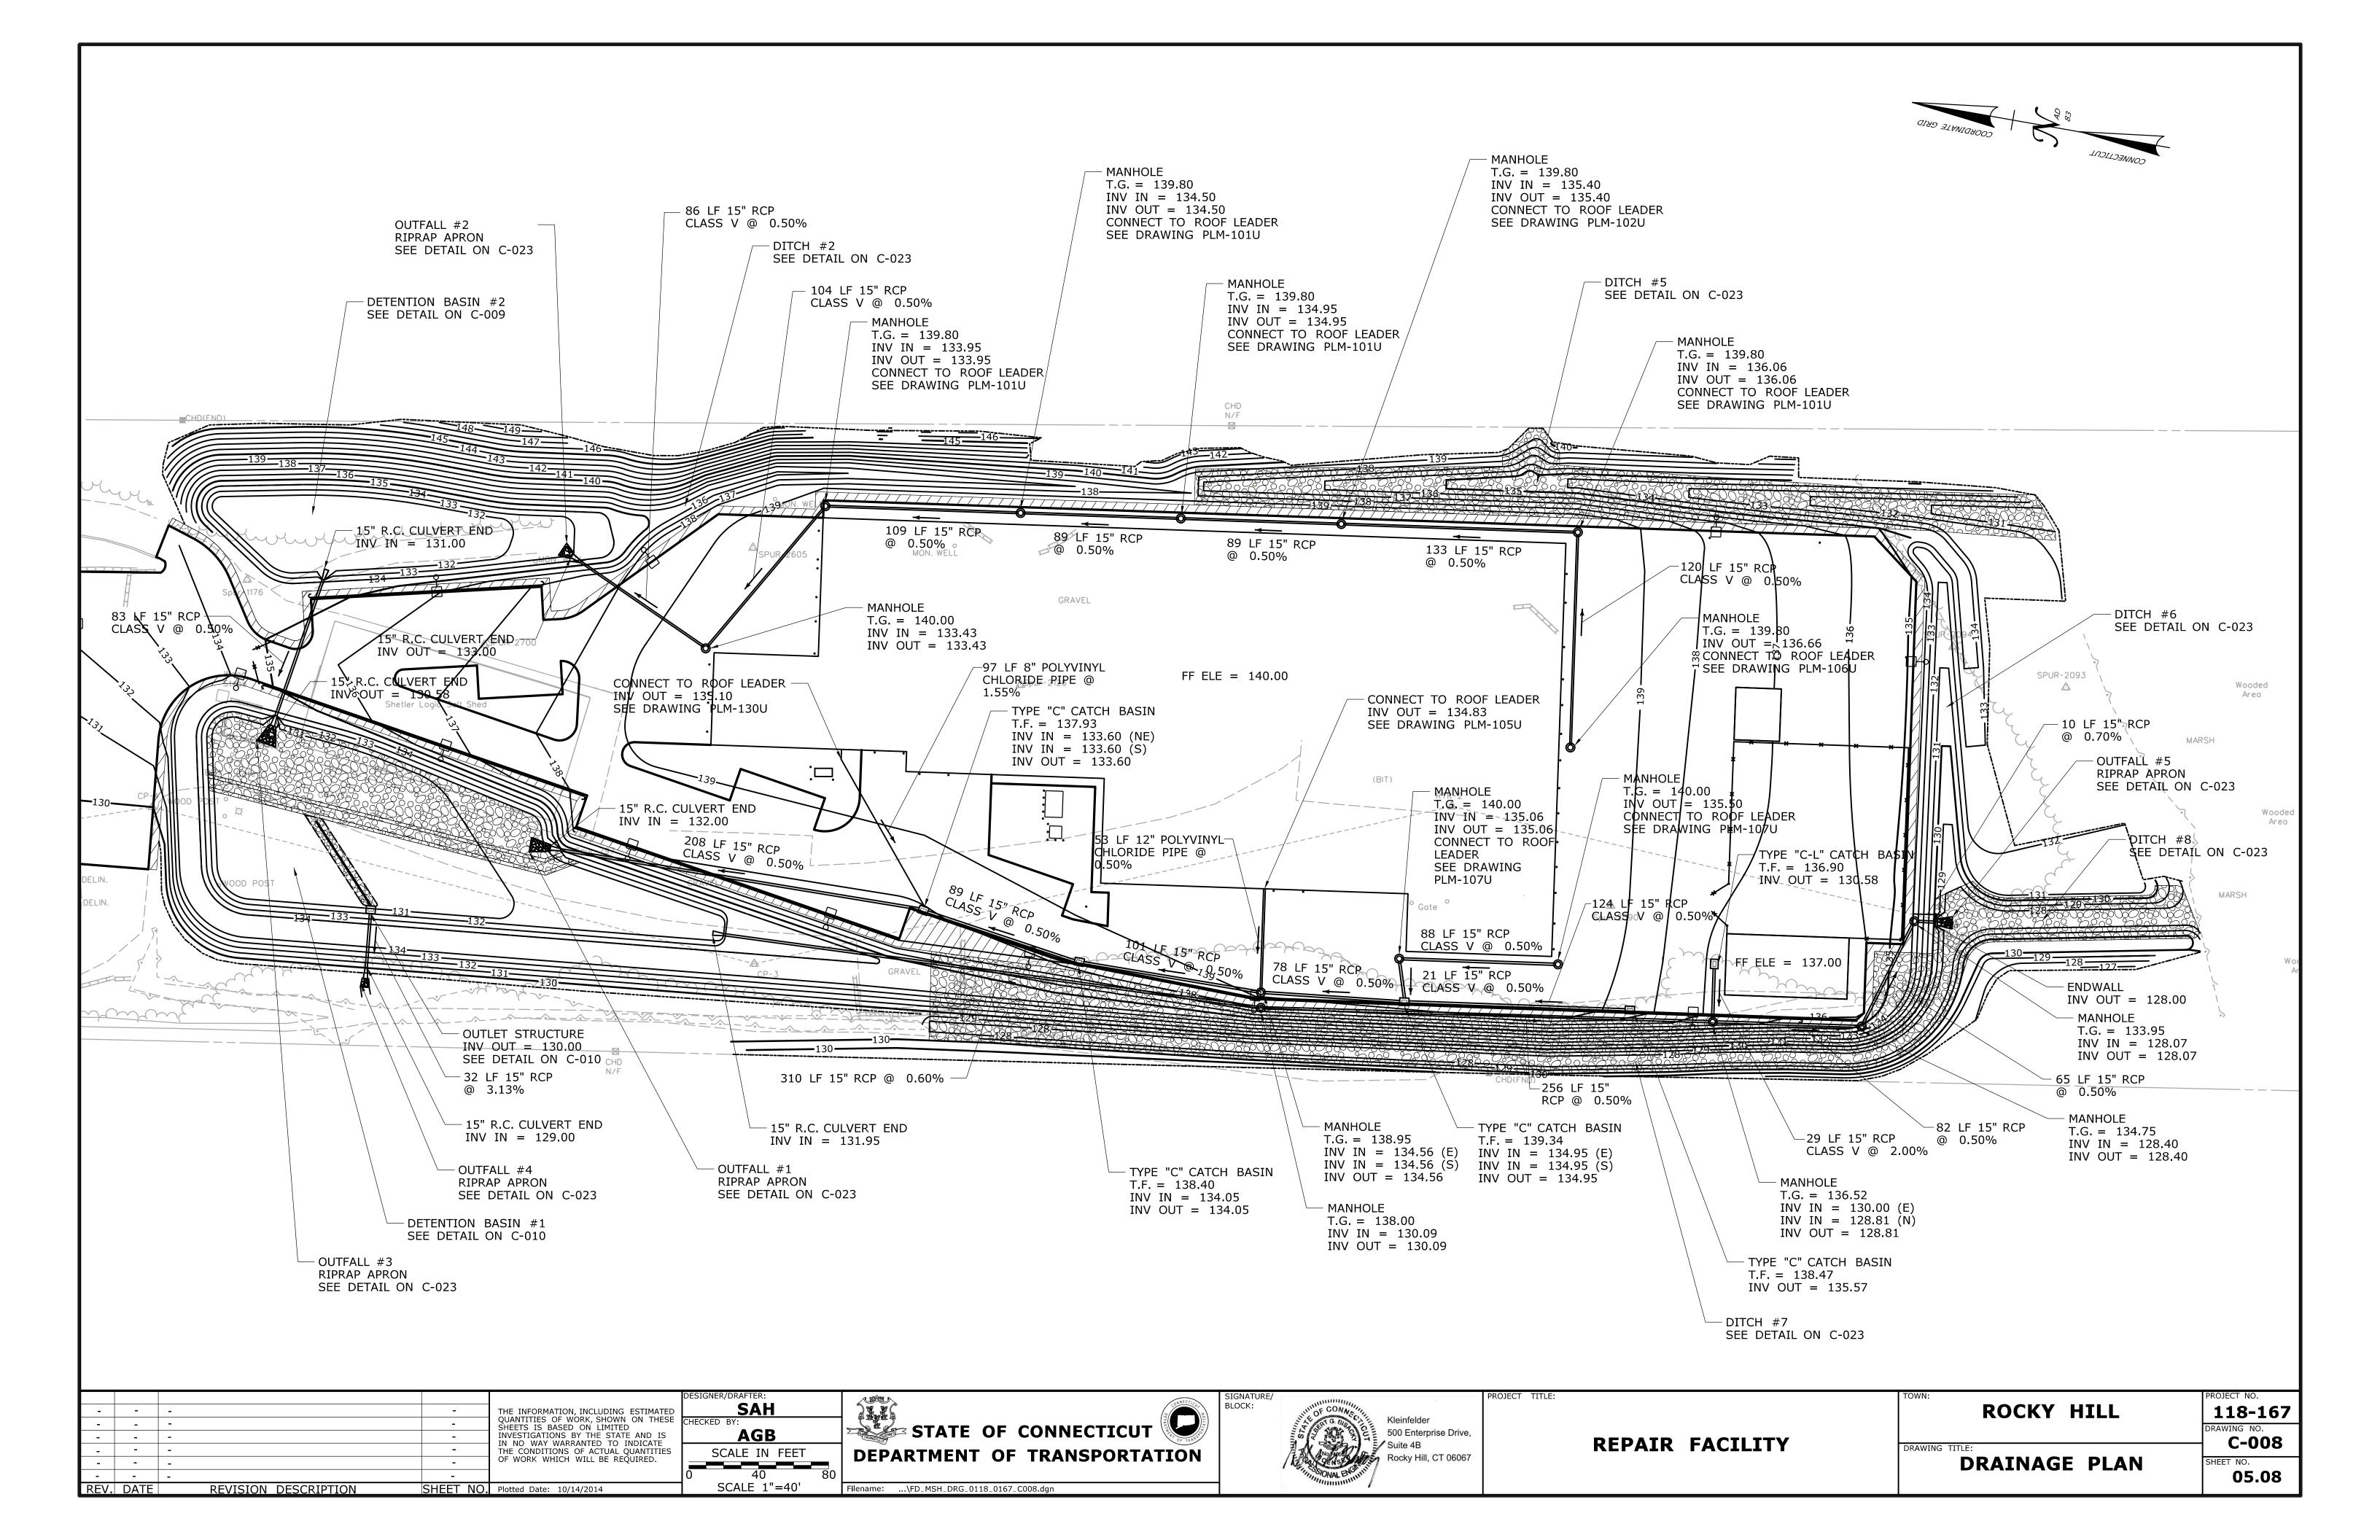


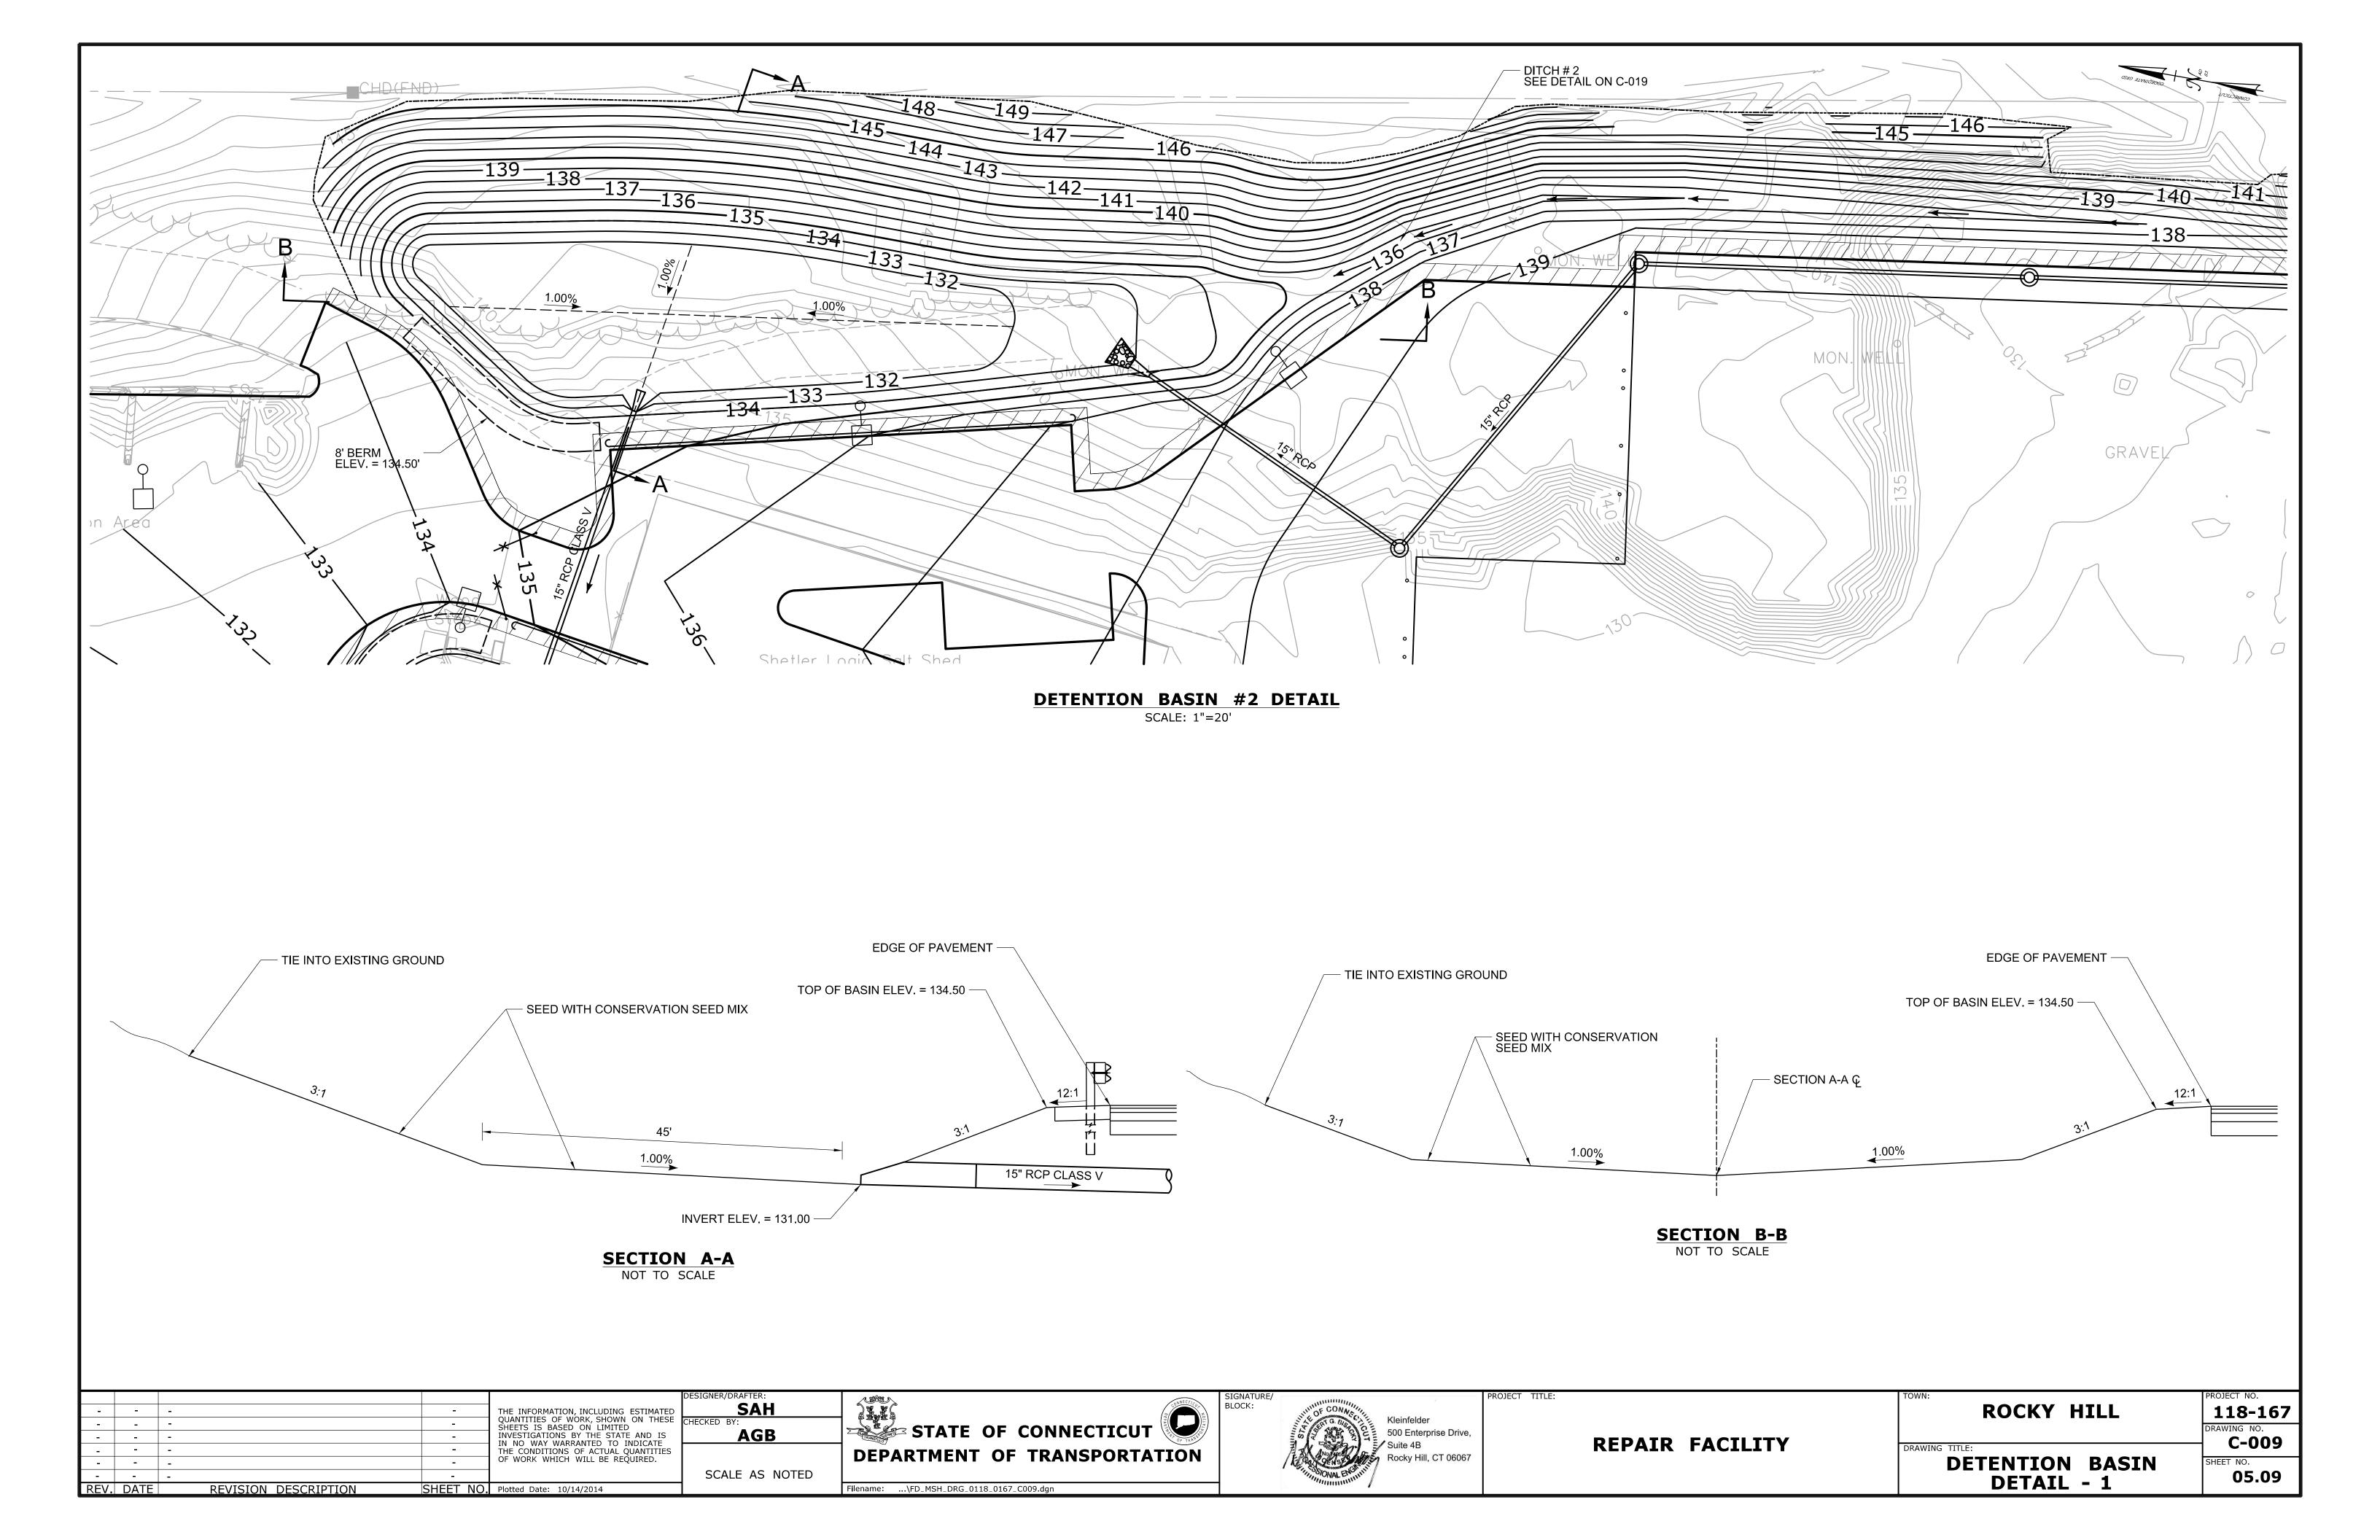


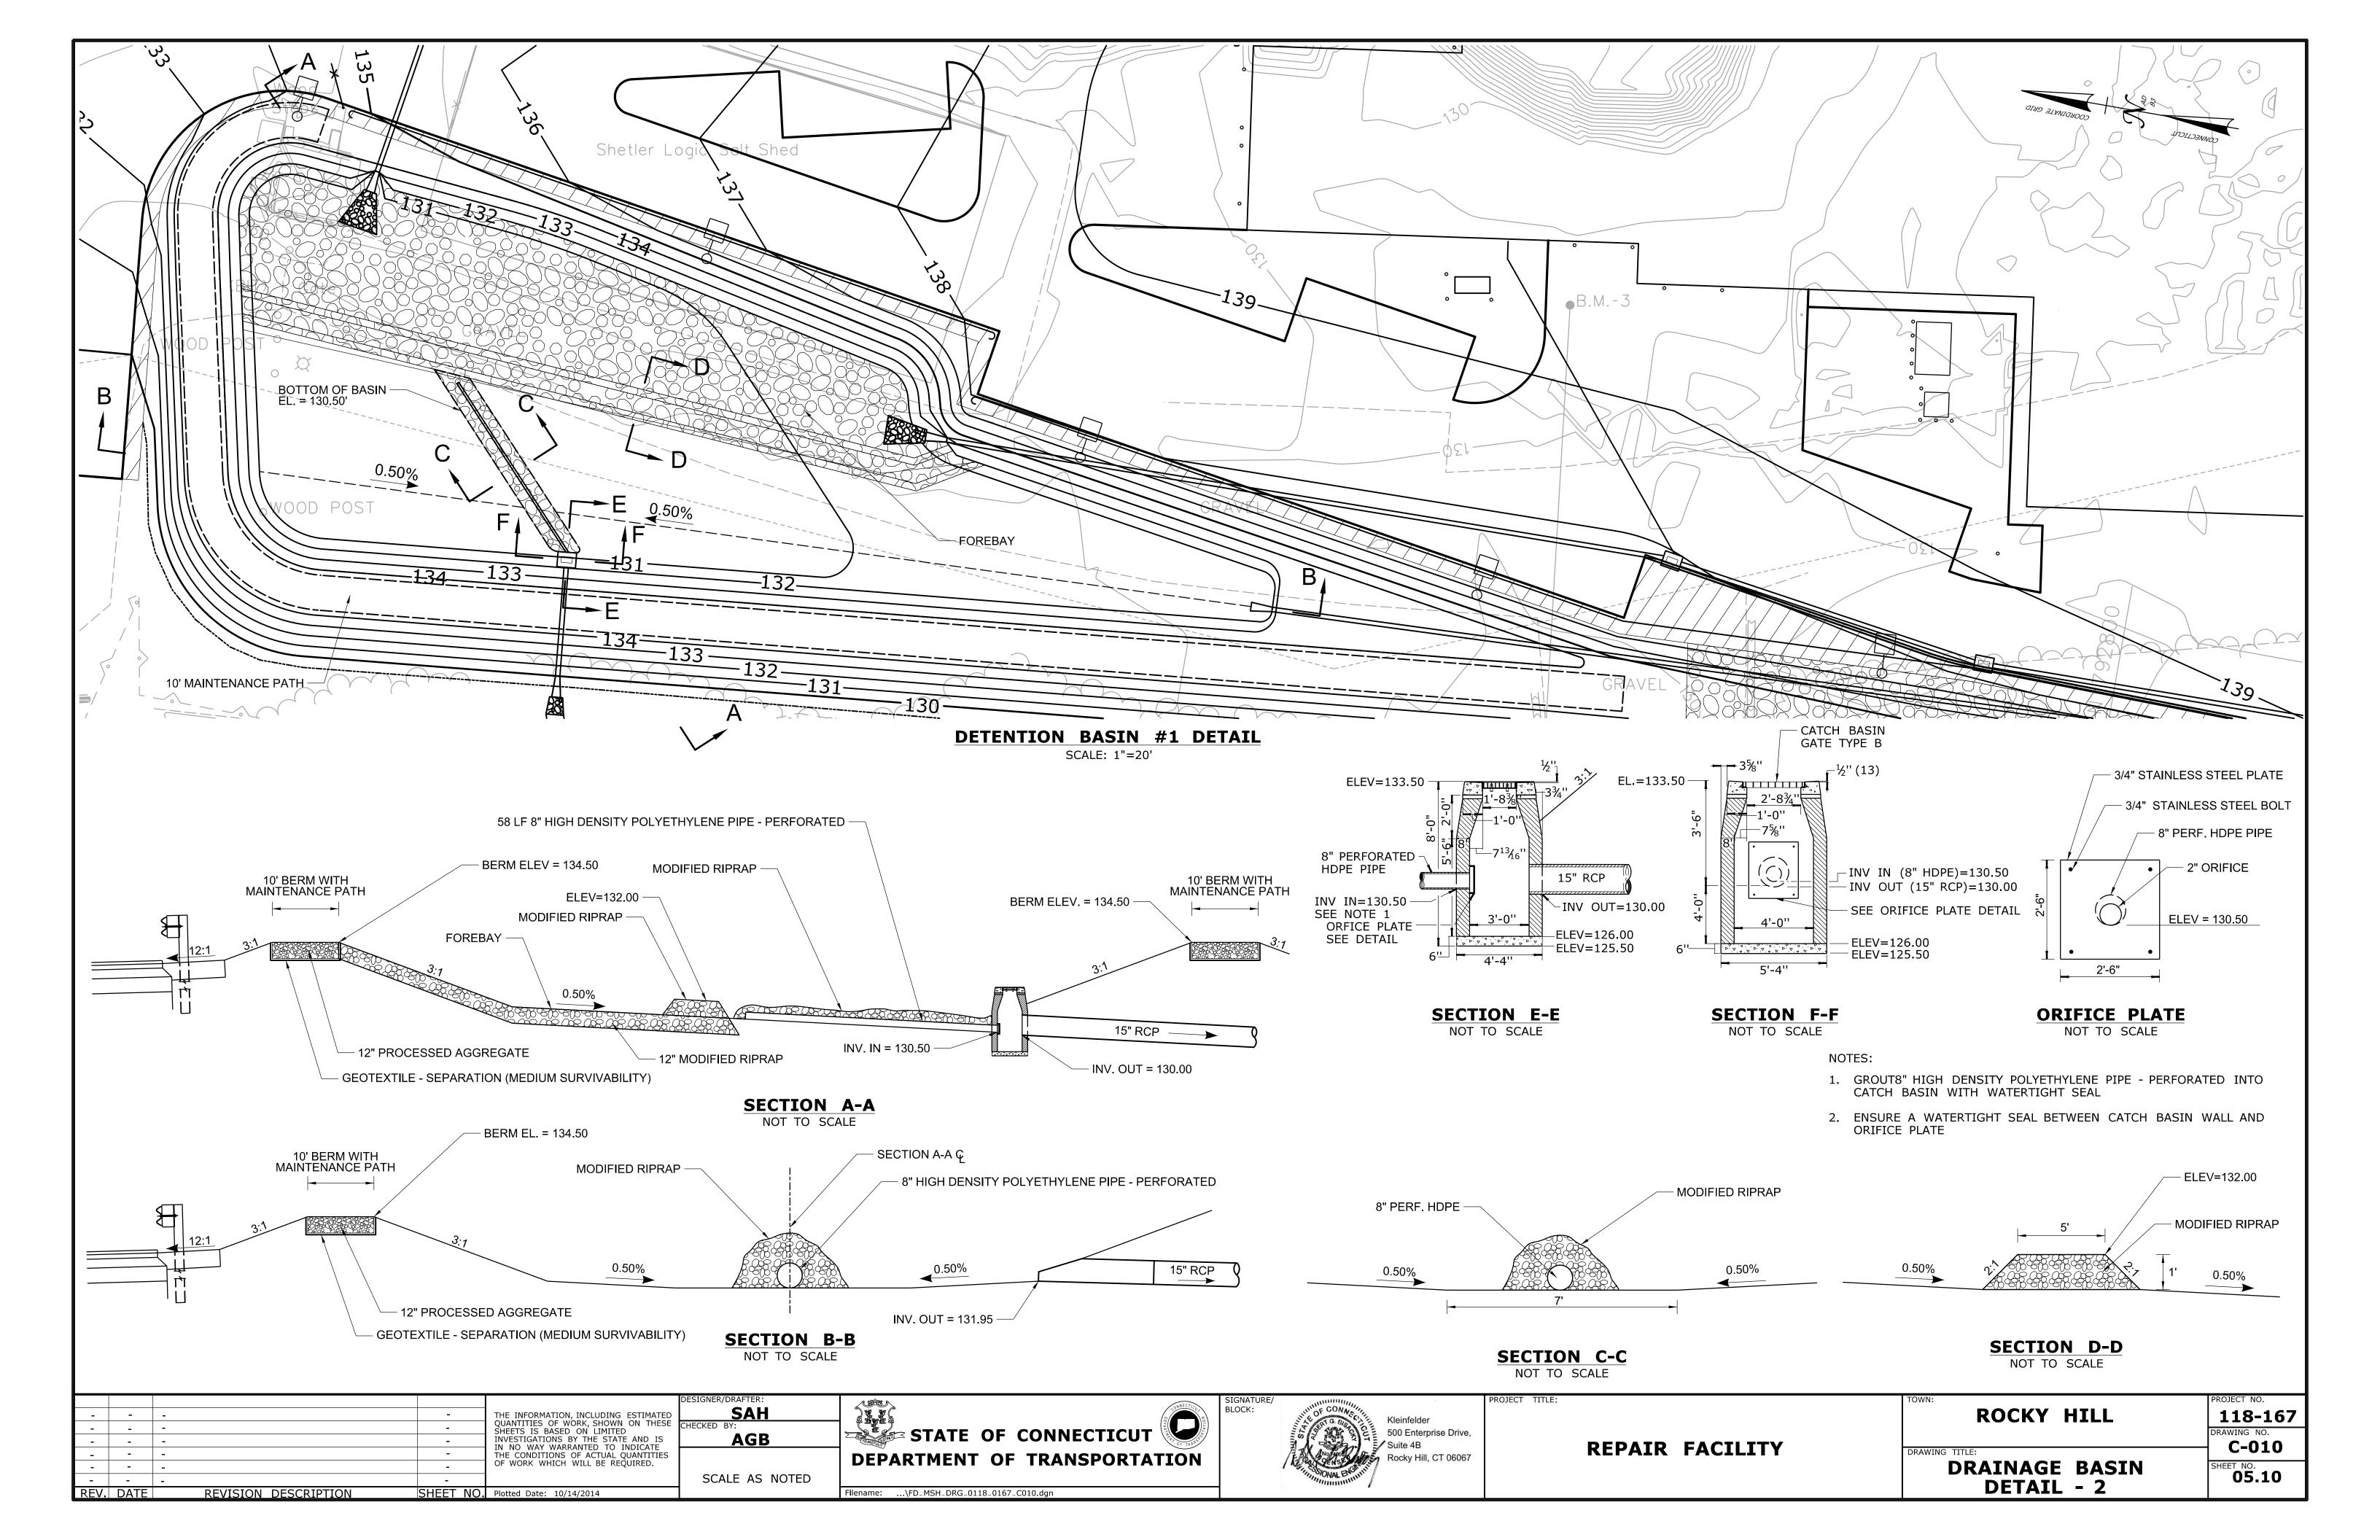


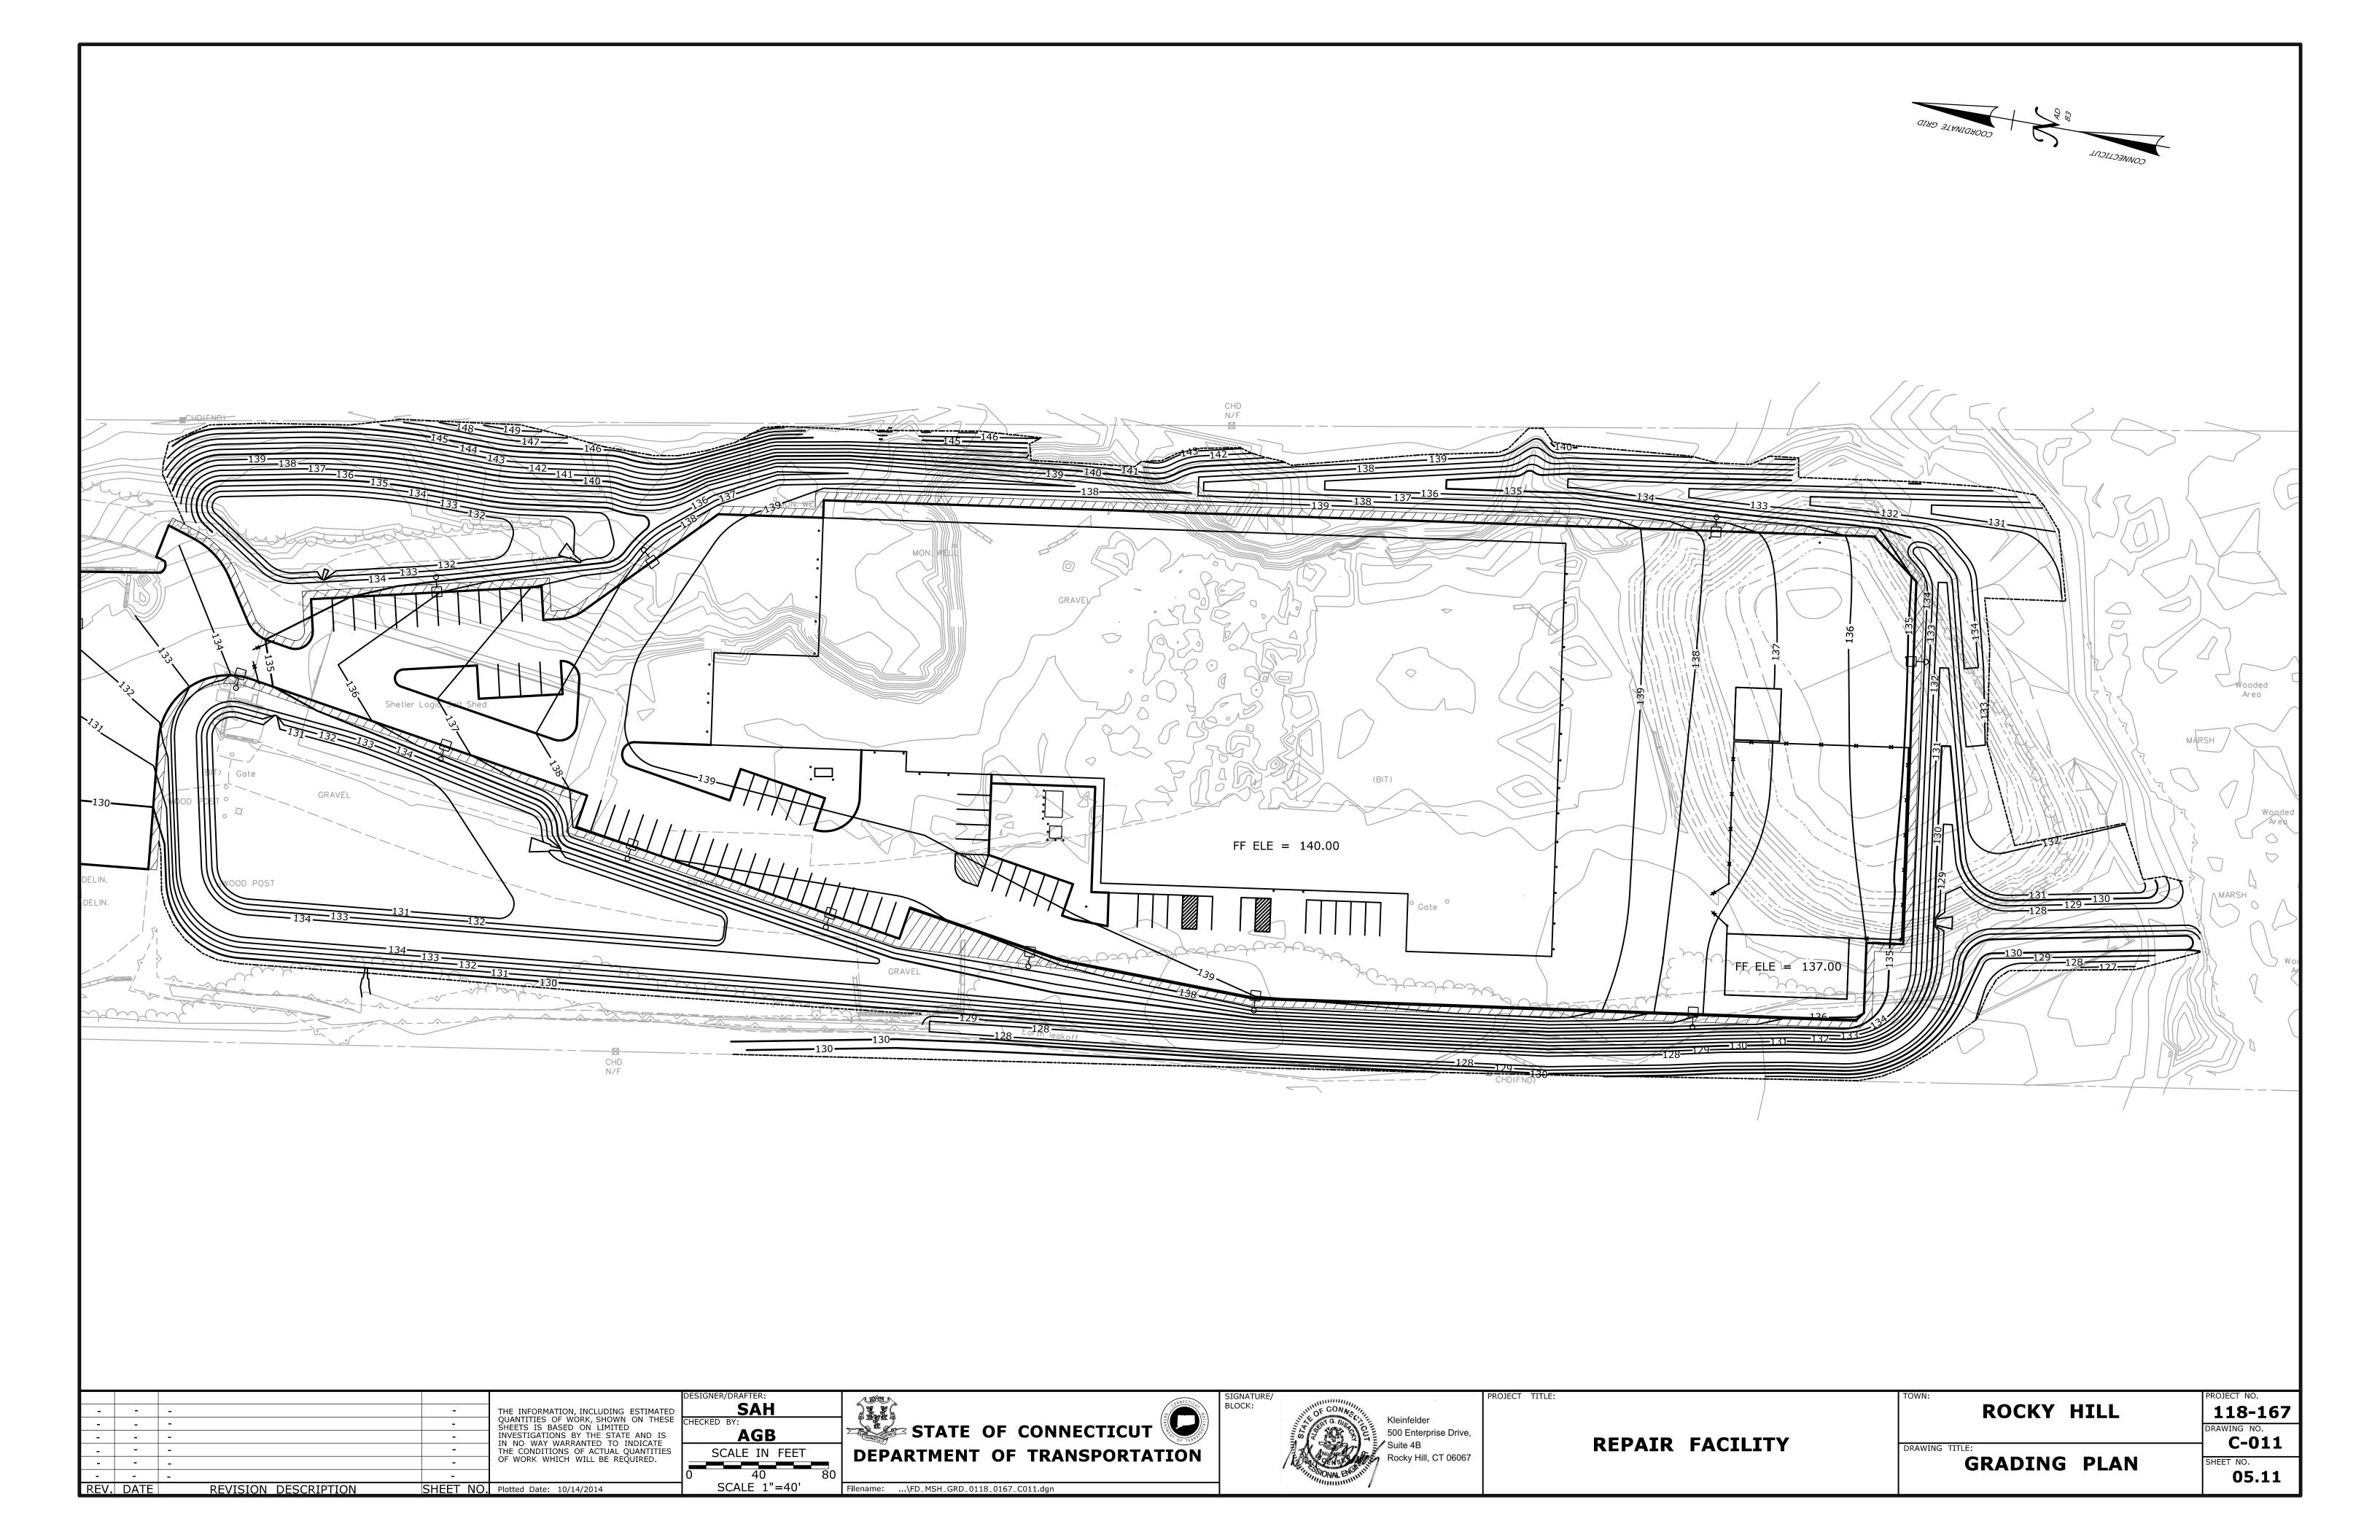


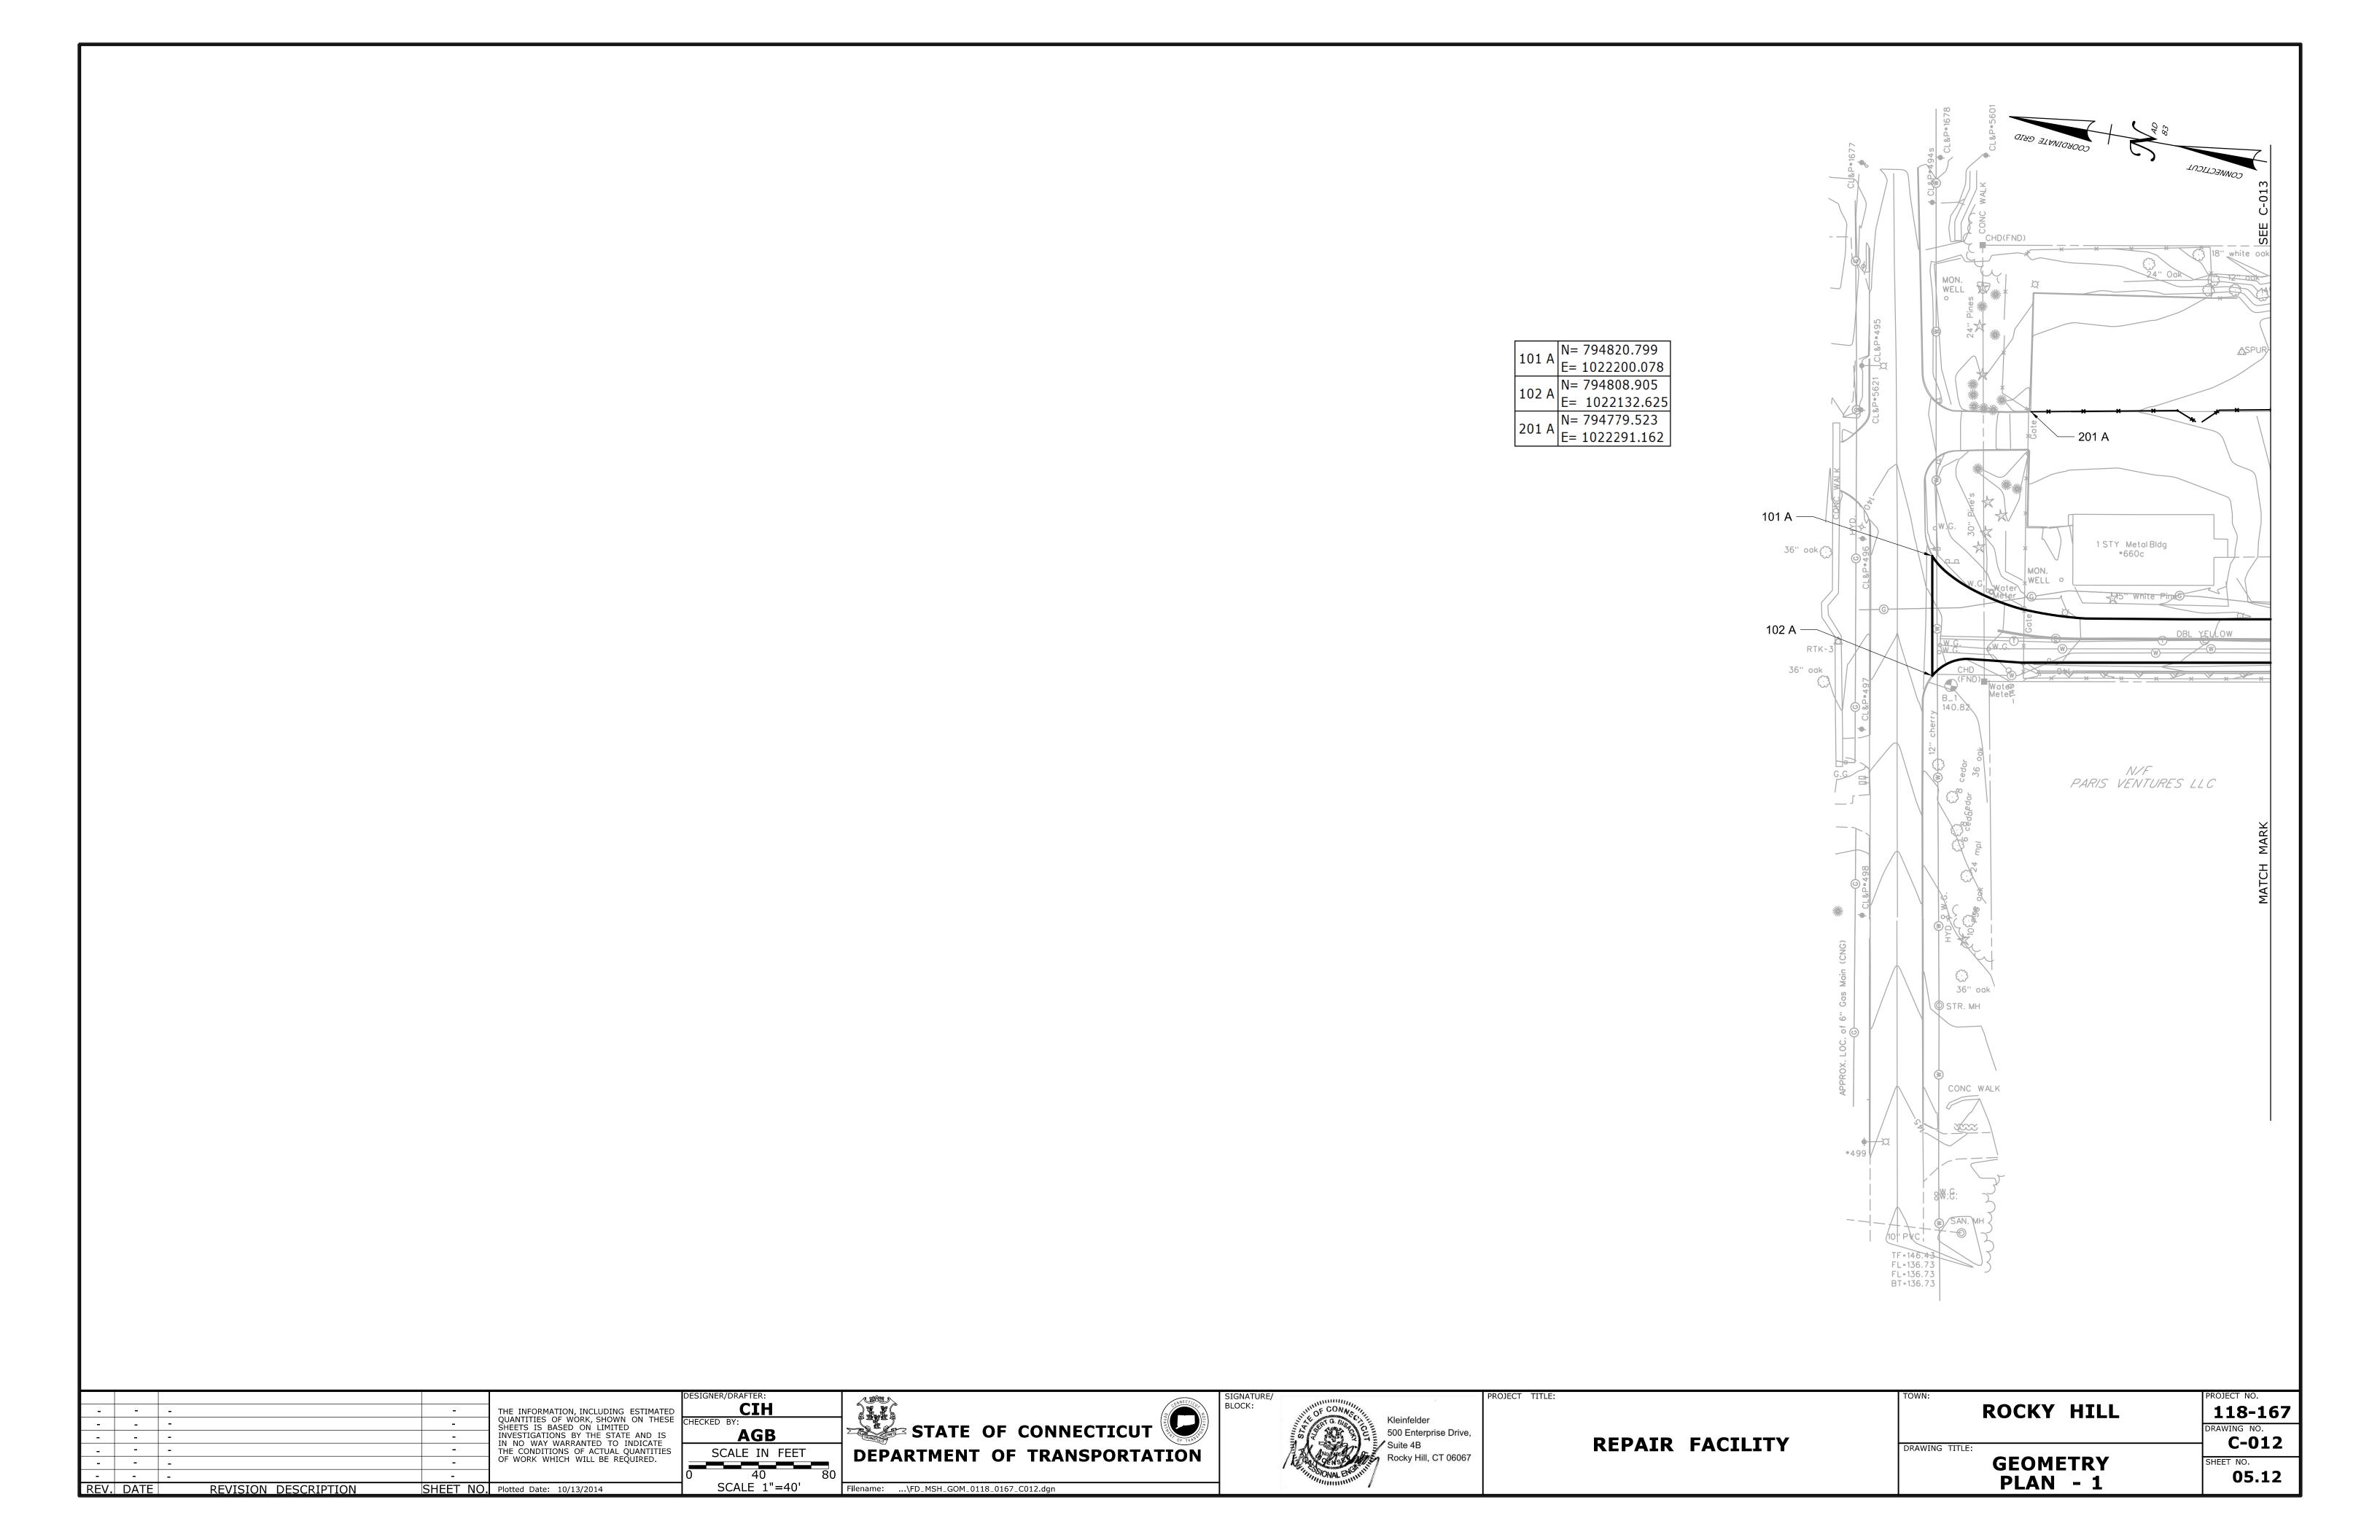


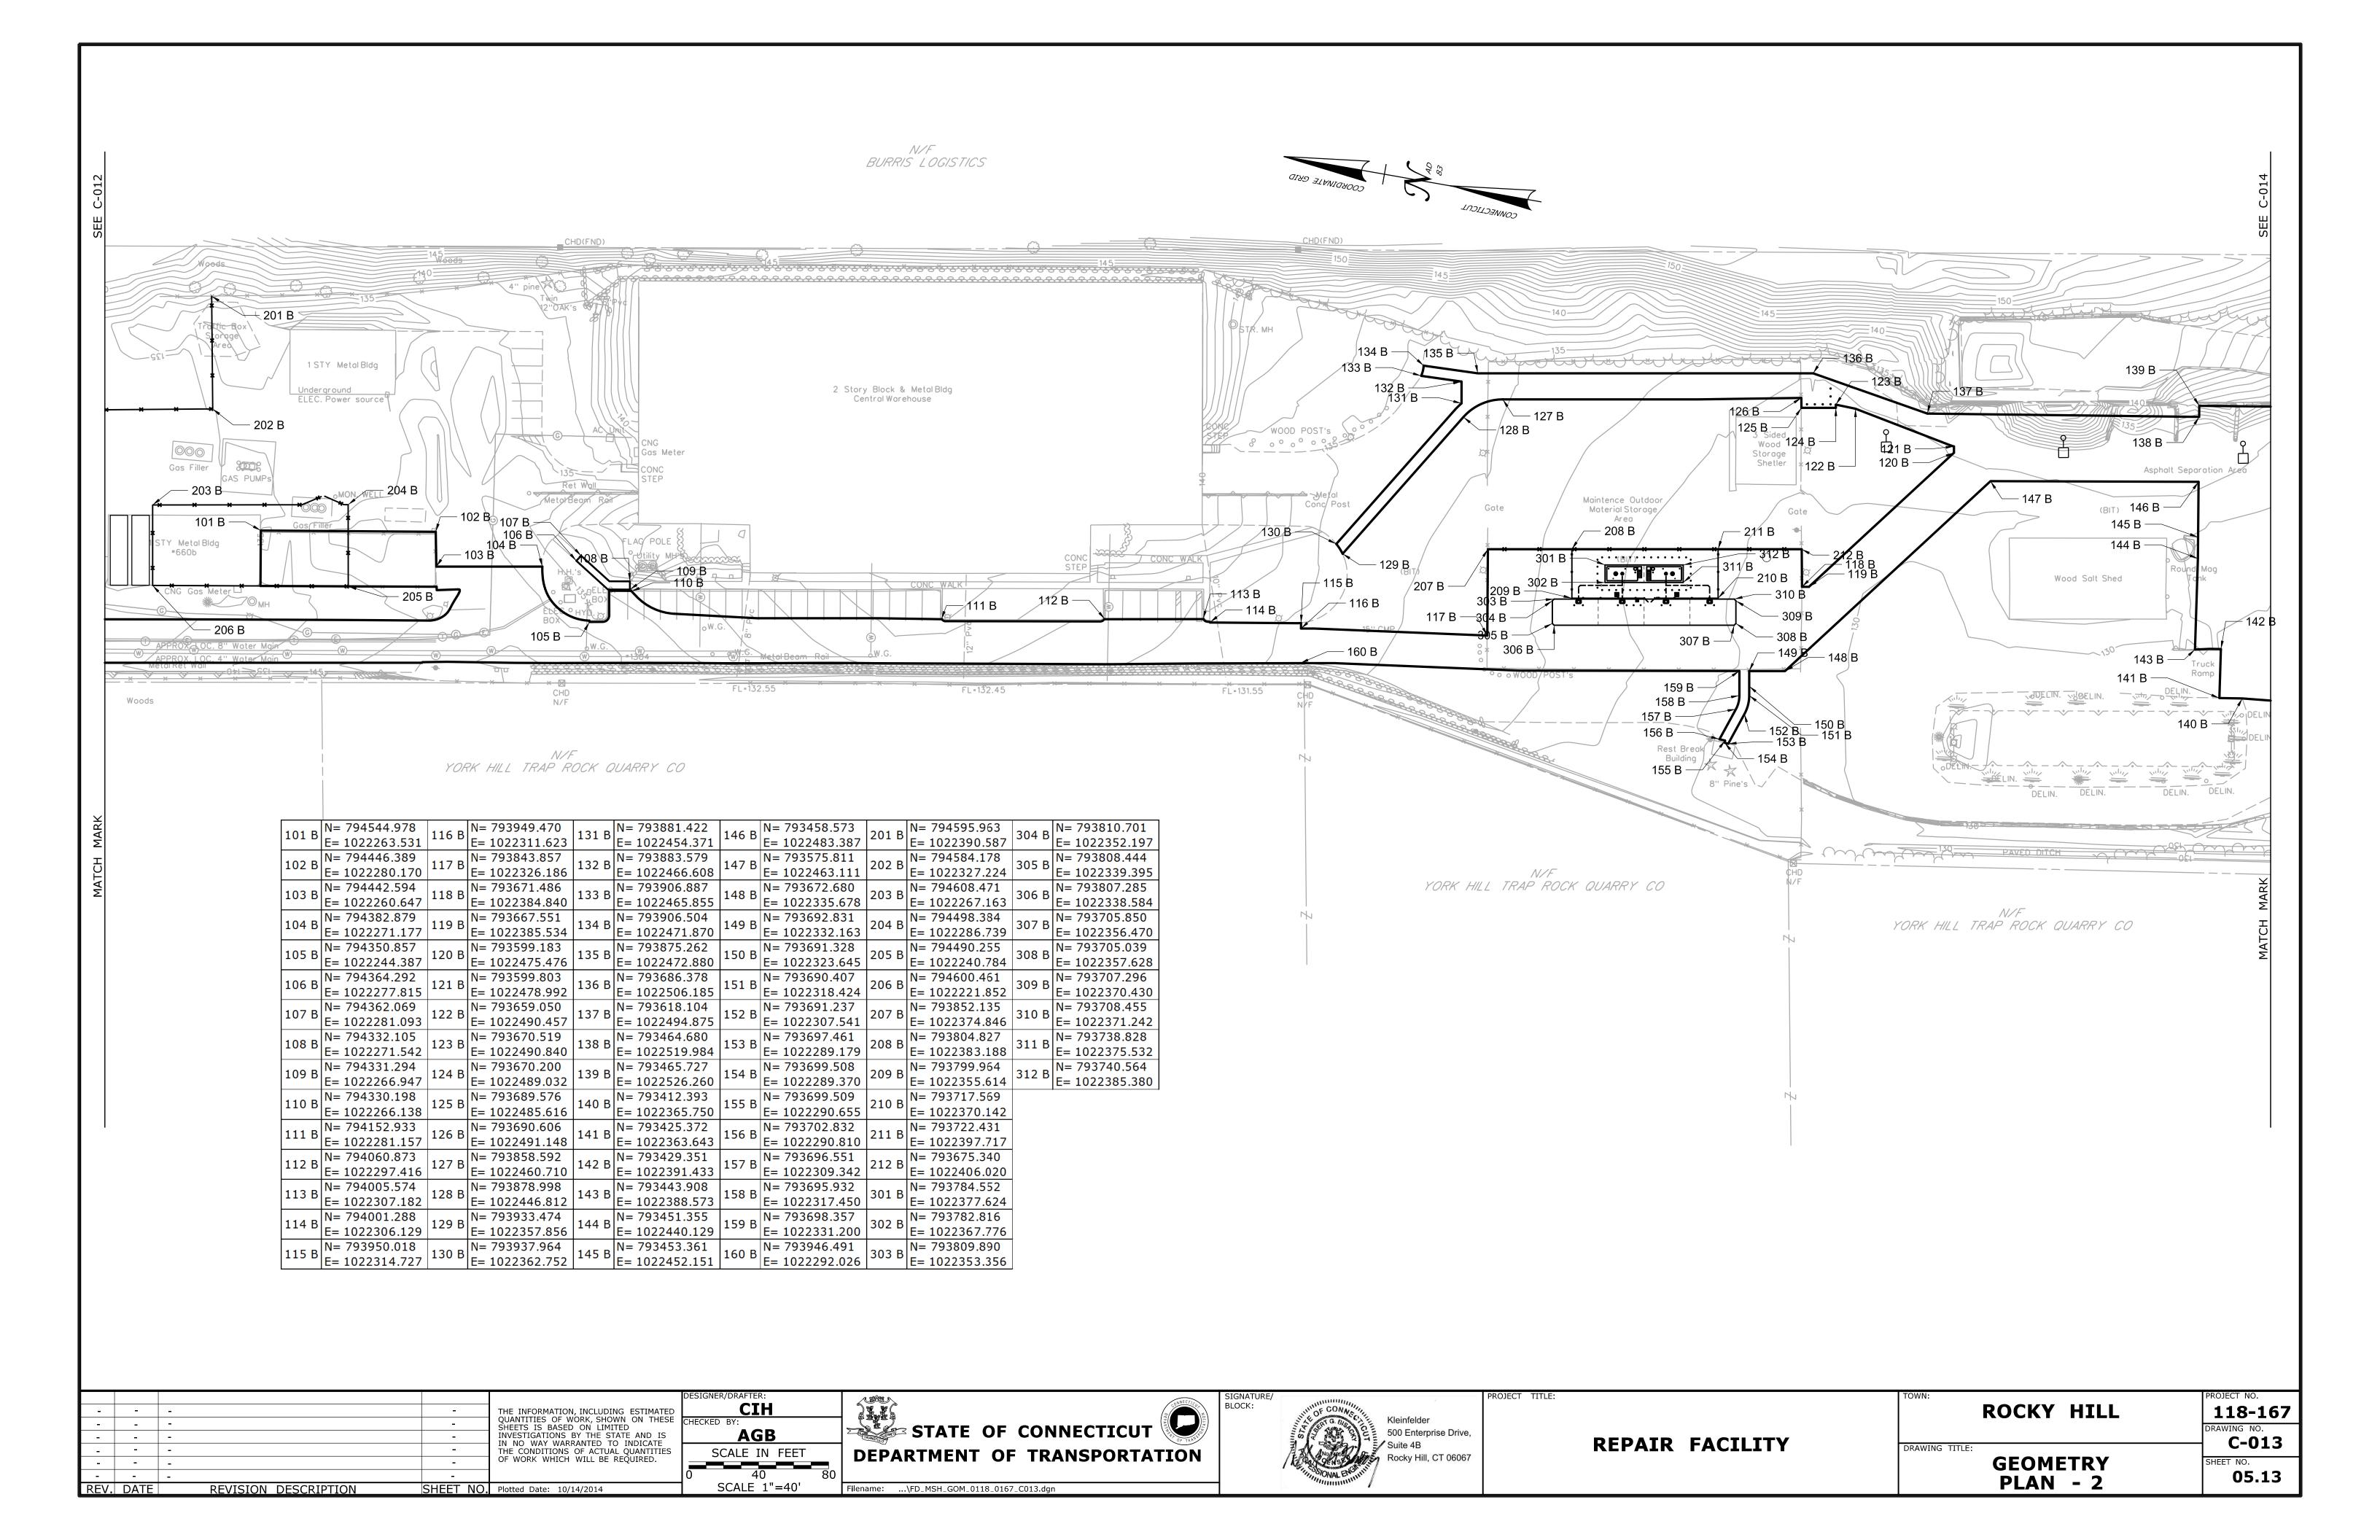

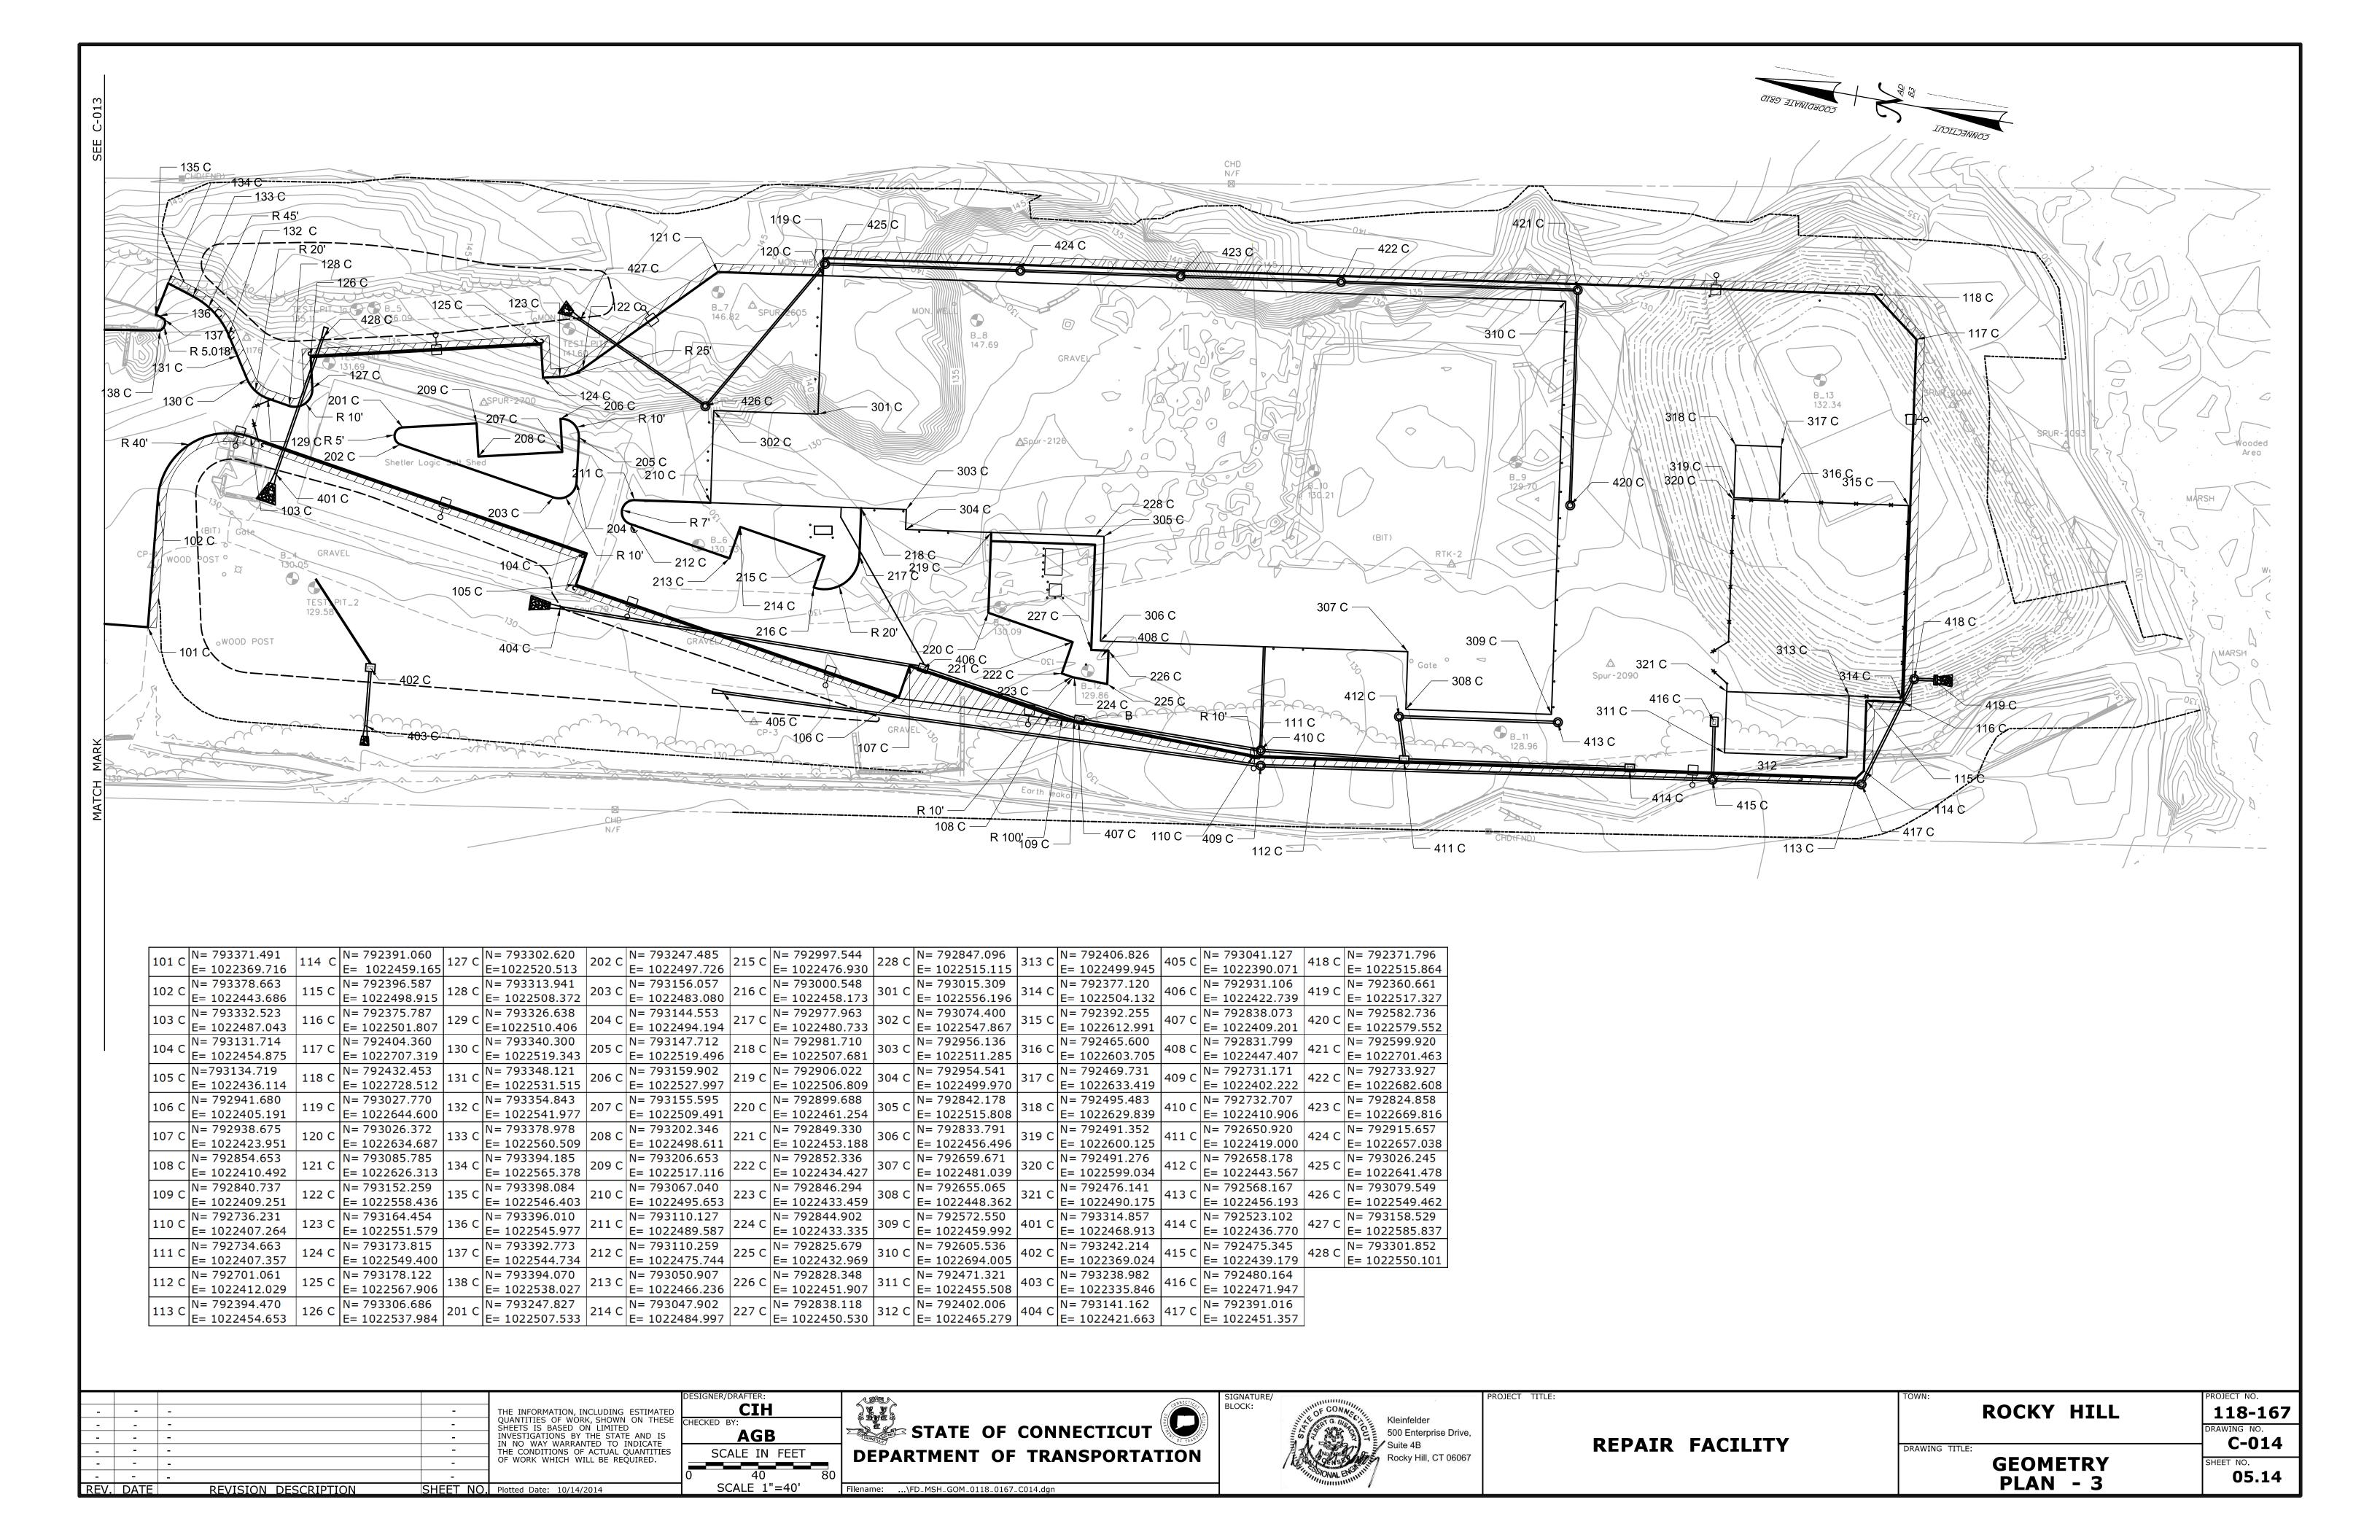


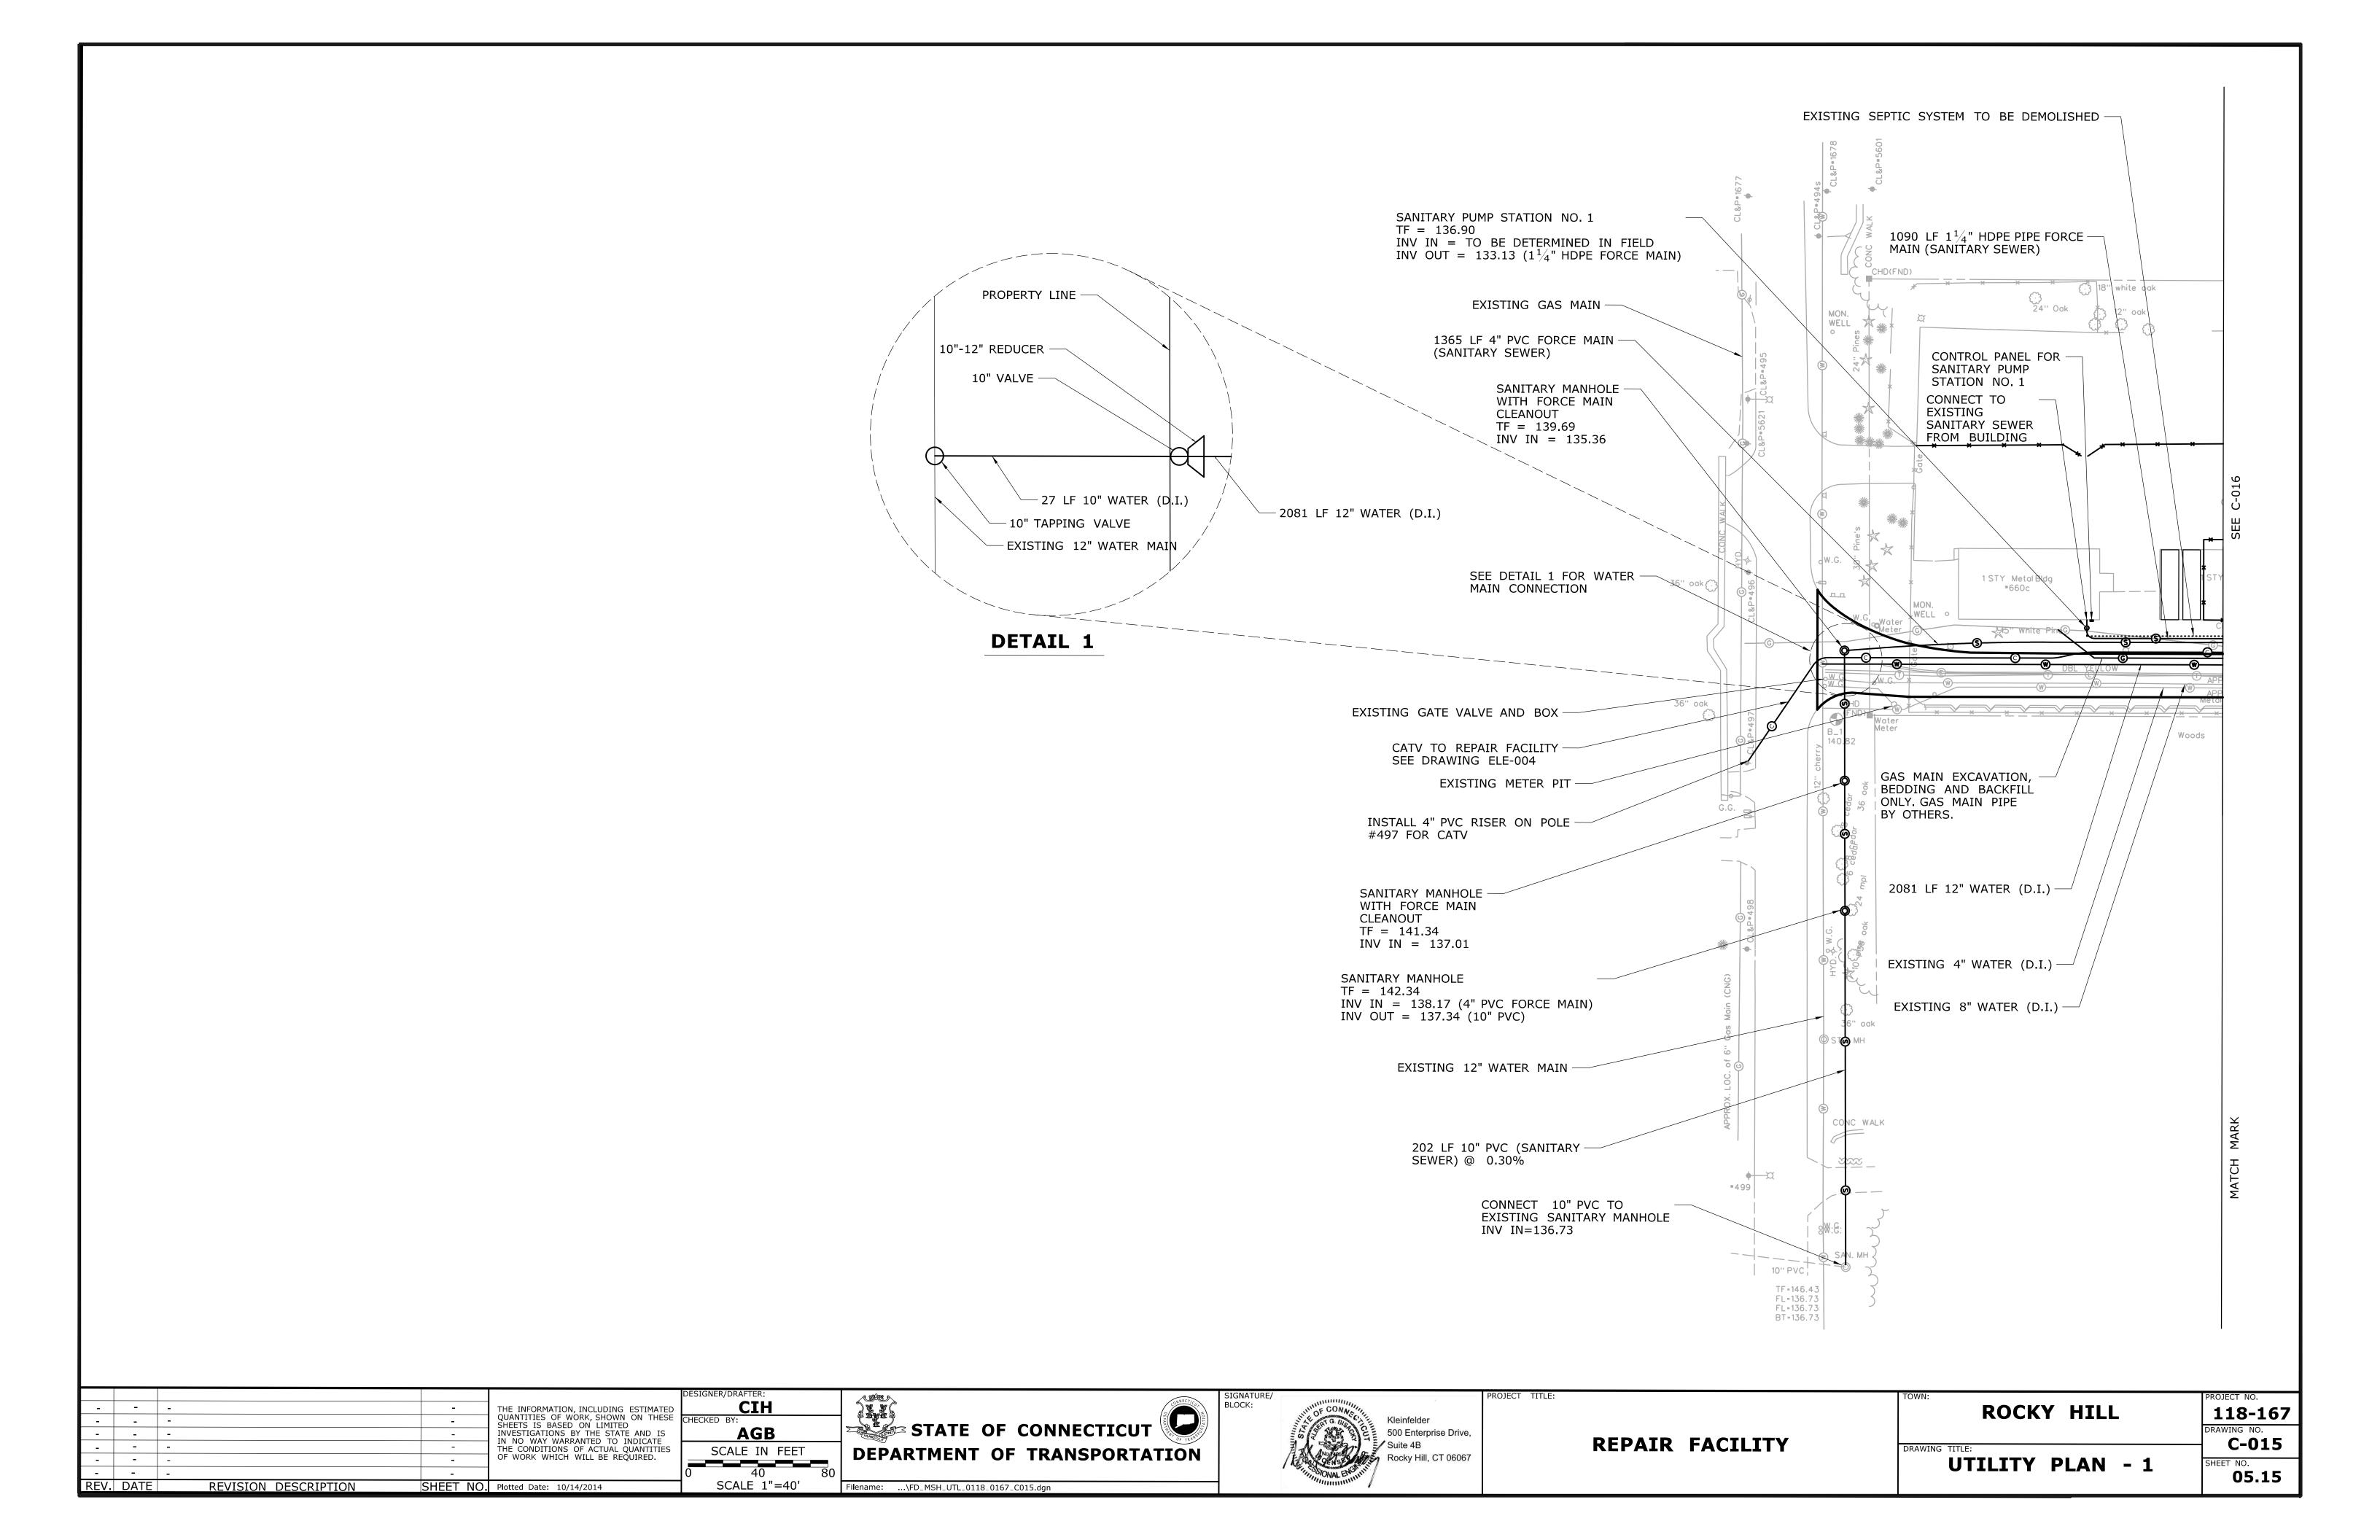

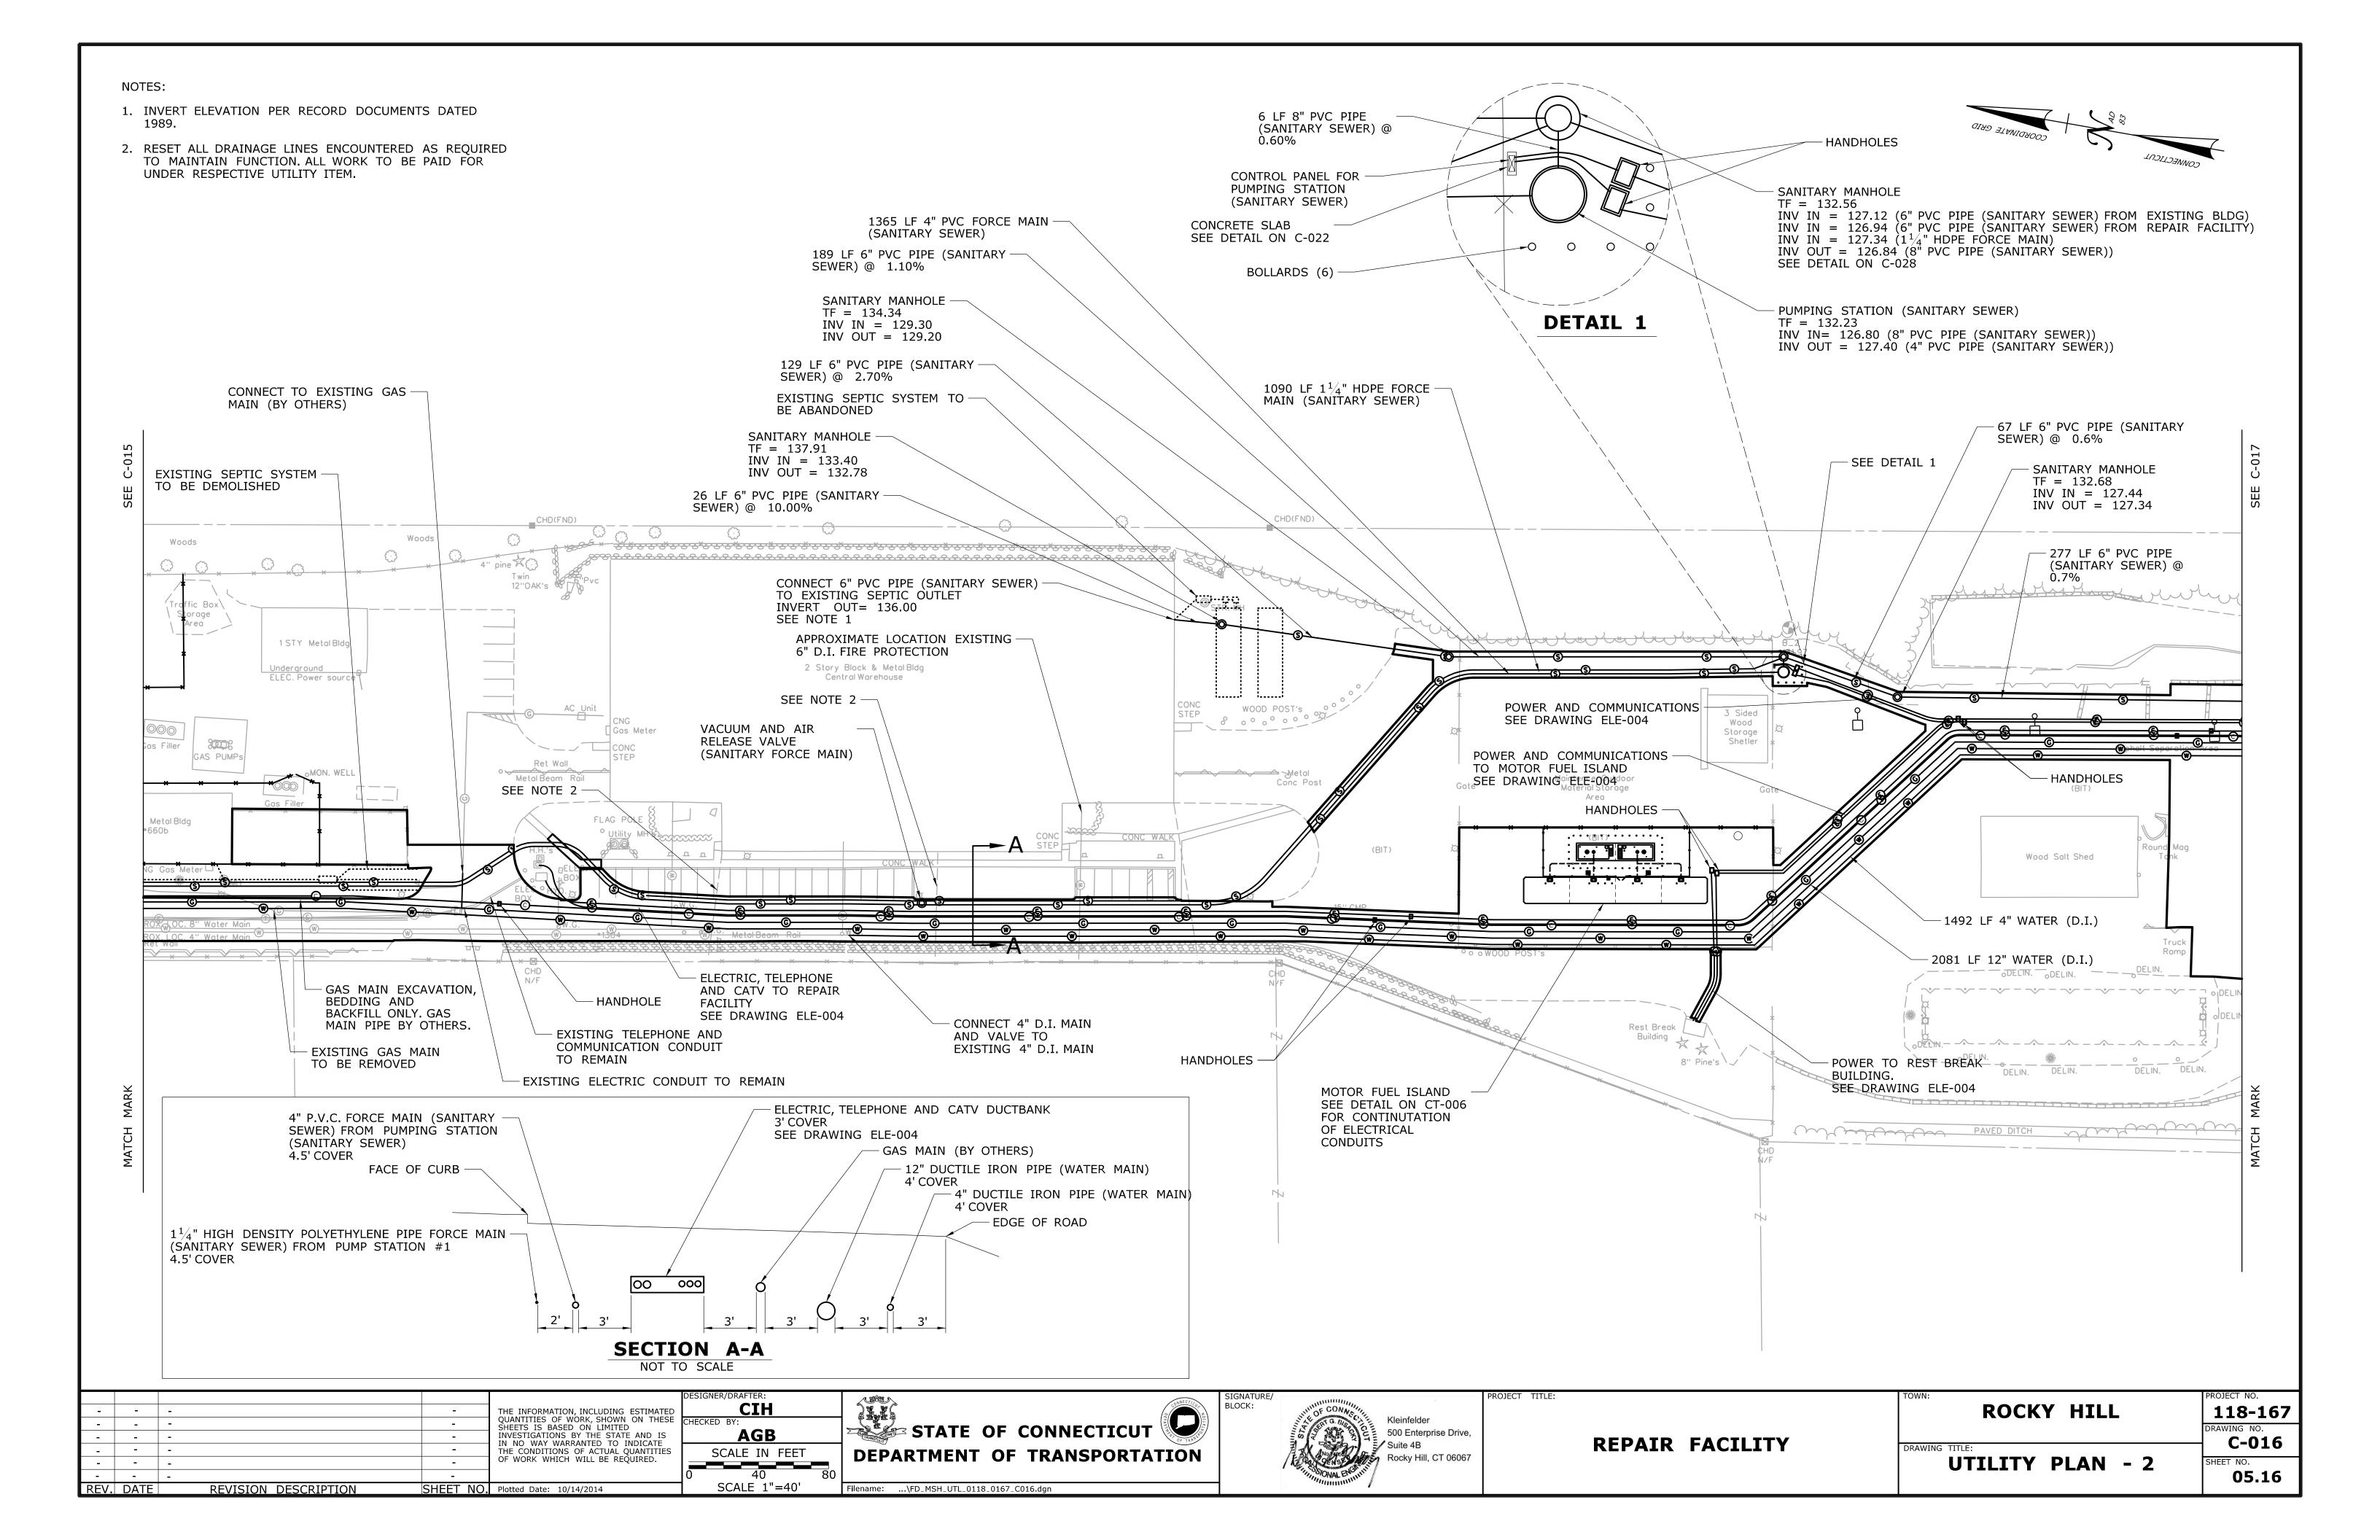


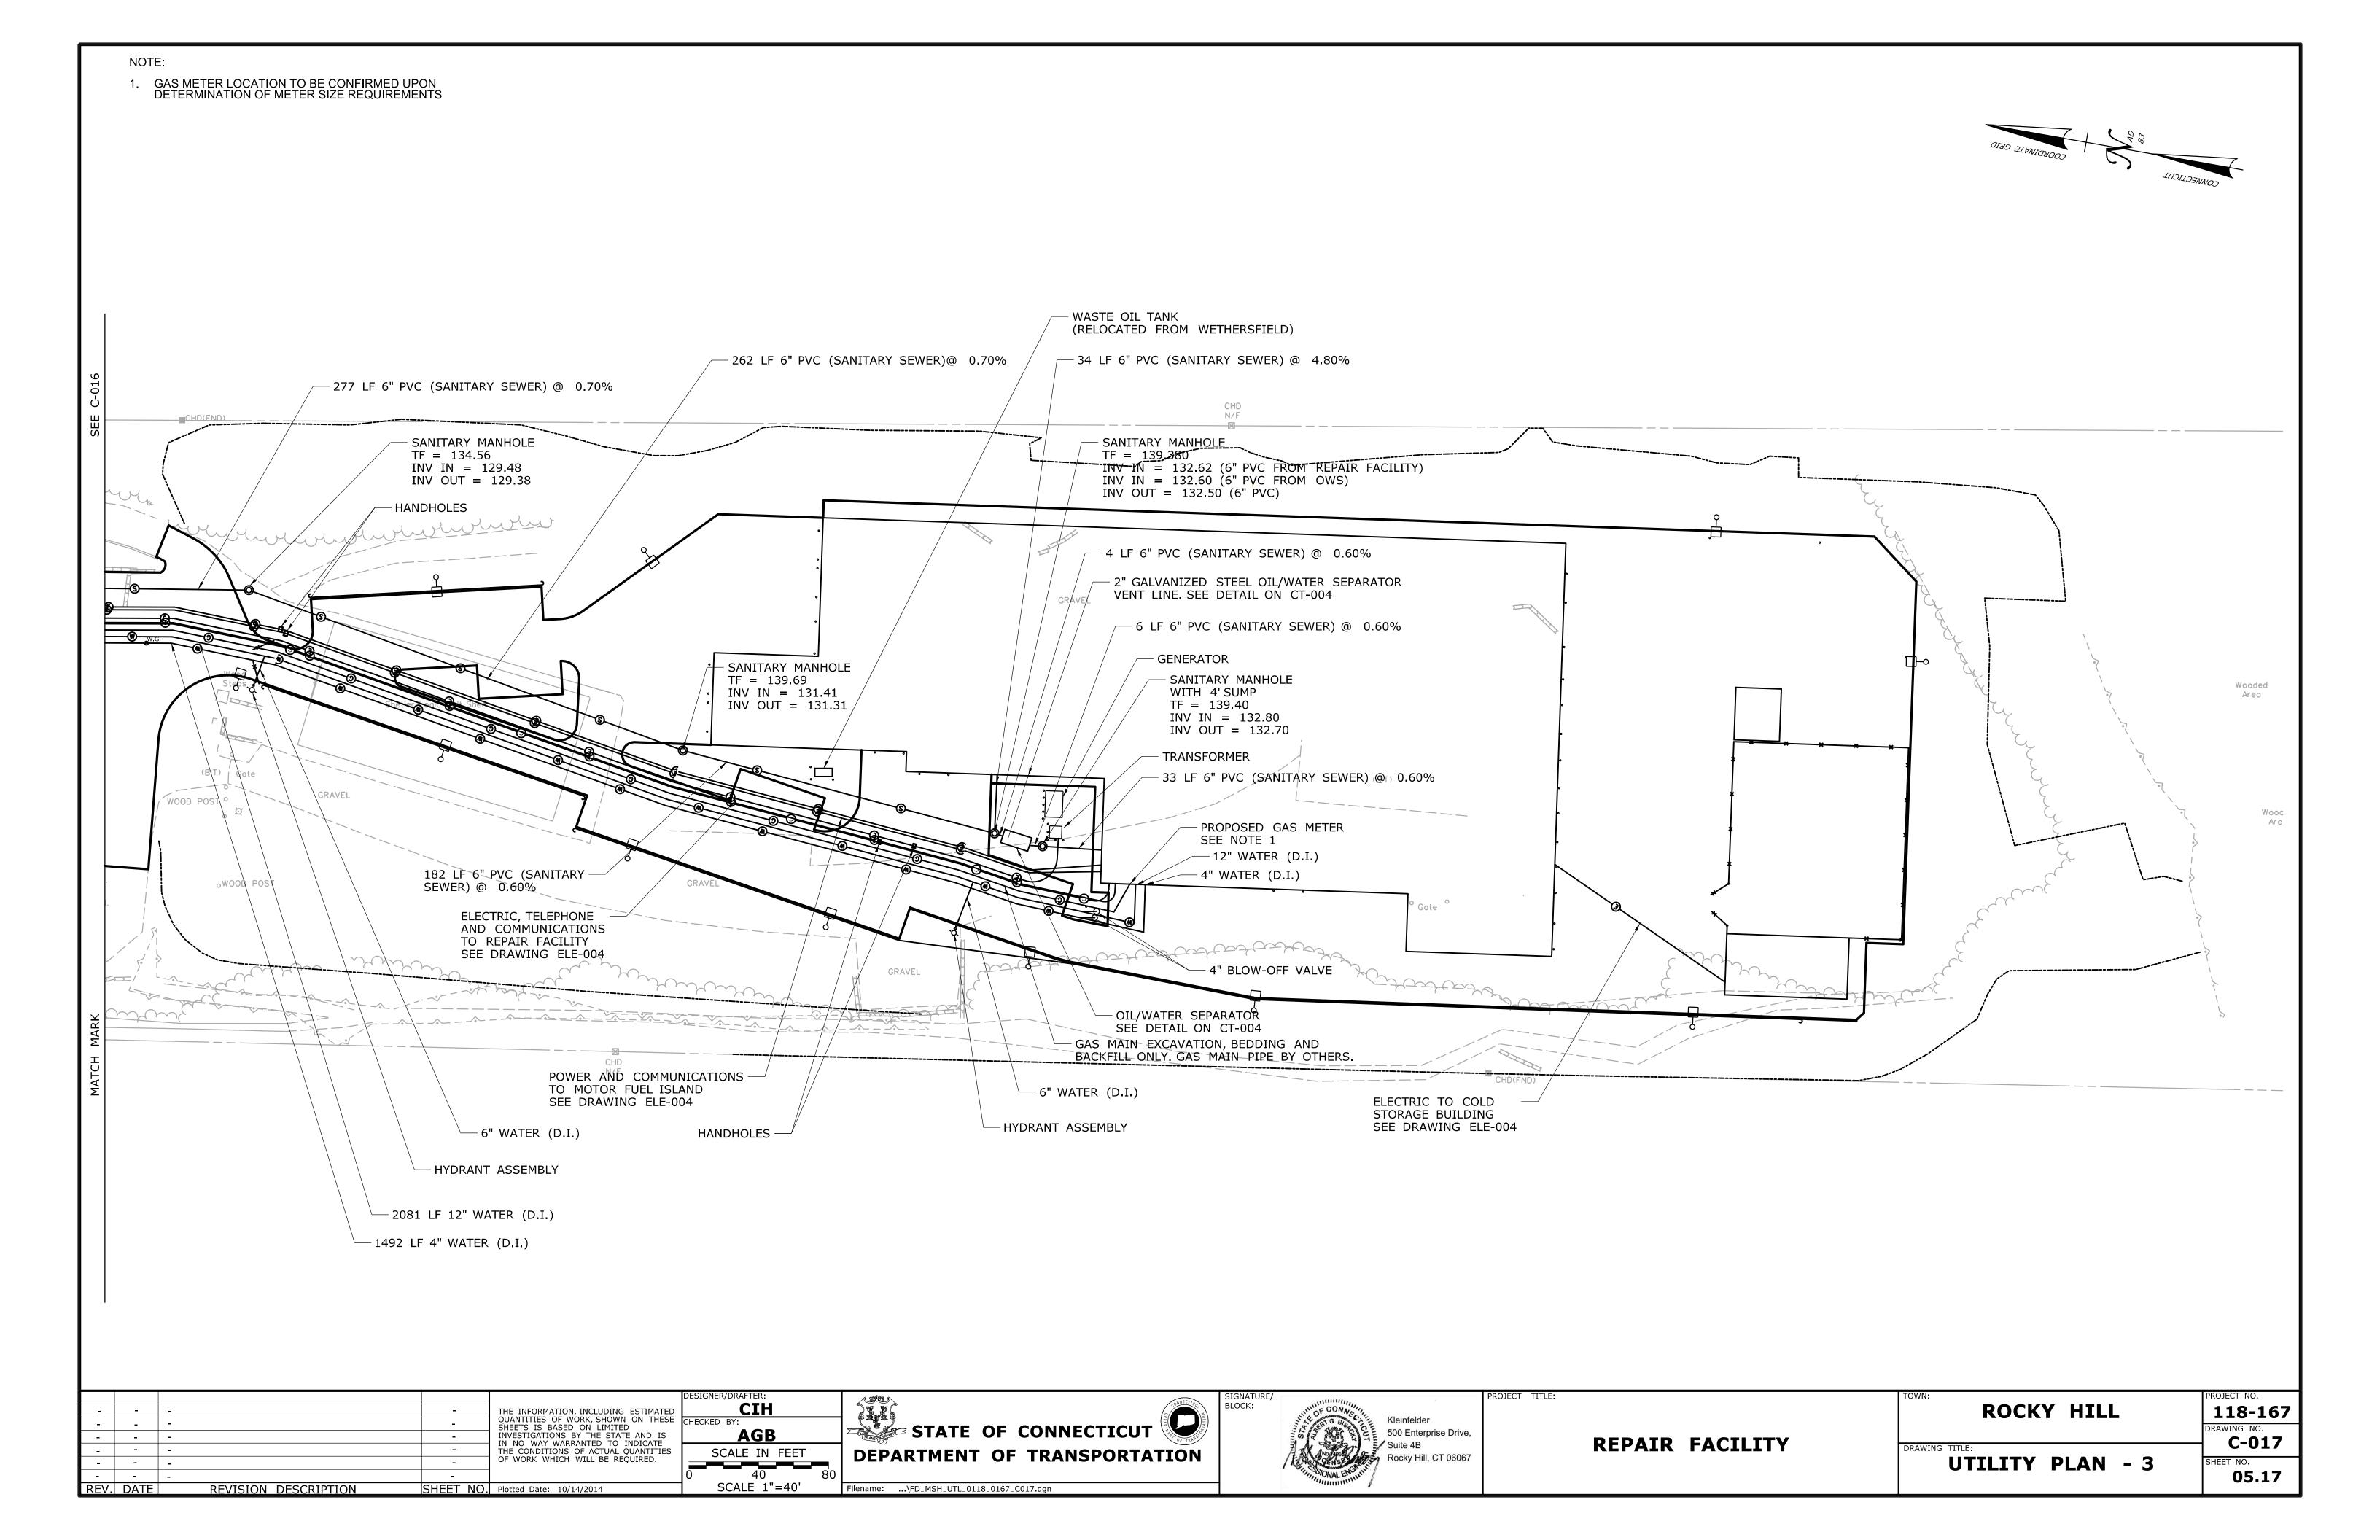

 UPON COMPLETION OF THE WORK, EXISTING PAVEMENT MARKINGS SHALL BE REESTABLISHED AS DIRECTED BY THE ENGINEER

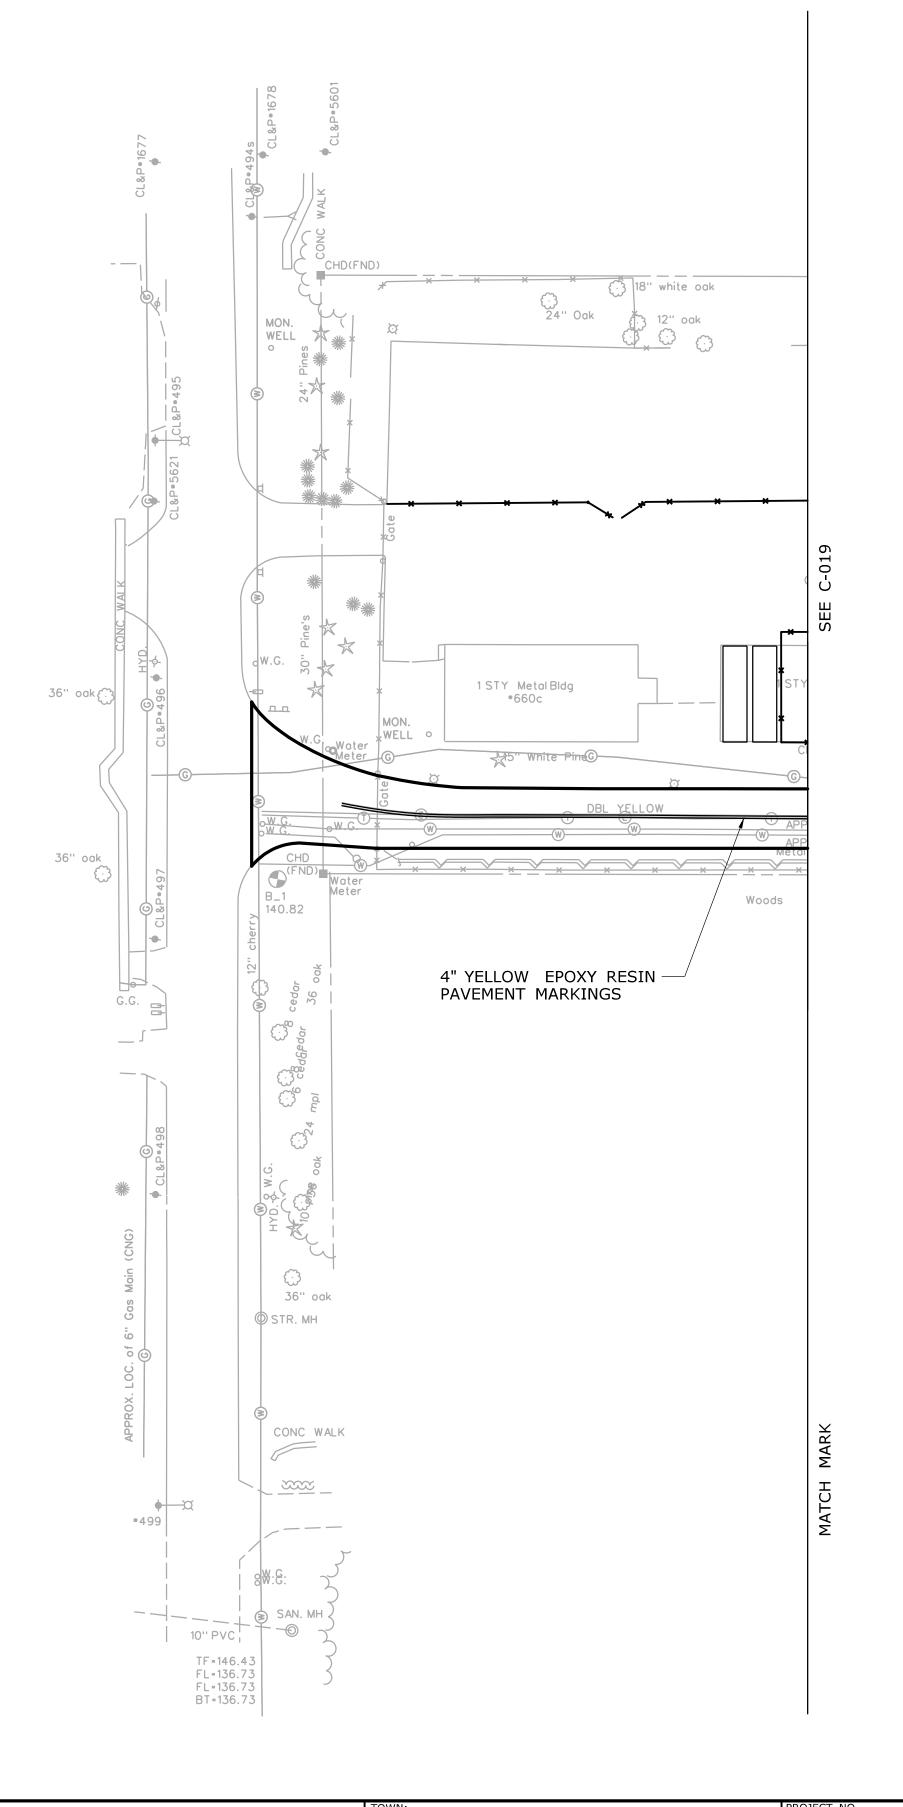


-	-	-	-	THE INFORMATION, INCLUDING ESTIMATED
-	_	-	-	QUANTITIES OF WORK, SHOWN ON THES SHEETS IS BASED ON LIMITED
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-	-	-	-	OF WORK WHICH WILL BE REQUIRED.
-	-	-	-	
REV.	DATE	REVISION DESCRIPTION	SHEET NO.	Plotted Date: 10/12/2014

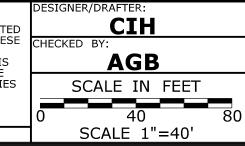

STATE OF CONNECTICUT


DEPARTMENT OF TRANSPORTATION


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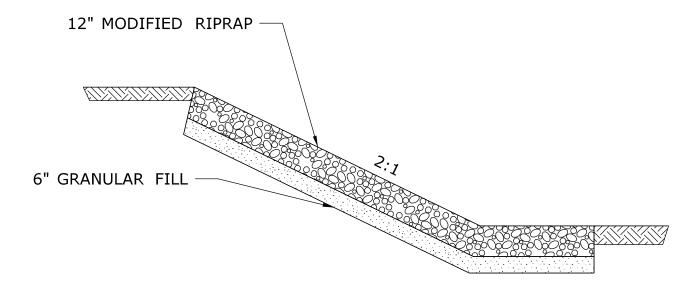


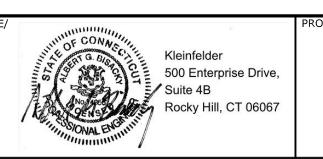REPAIR	FACILITY

PAVEMENT MARKING PLAN - 1	SHEET NO. 05.18
DRAWING TITLE:	DRAWING NO. C-018
ROCKY HILL	118-167



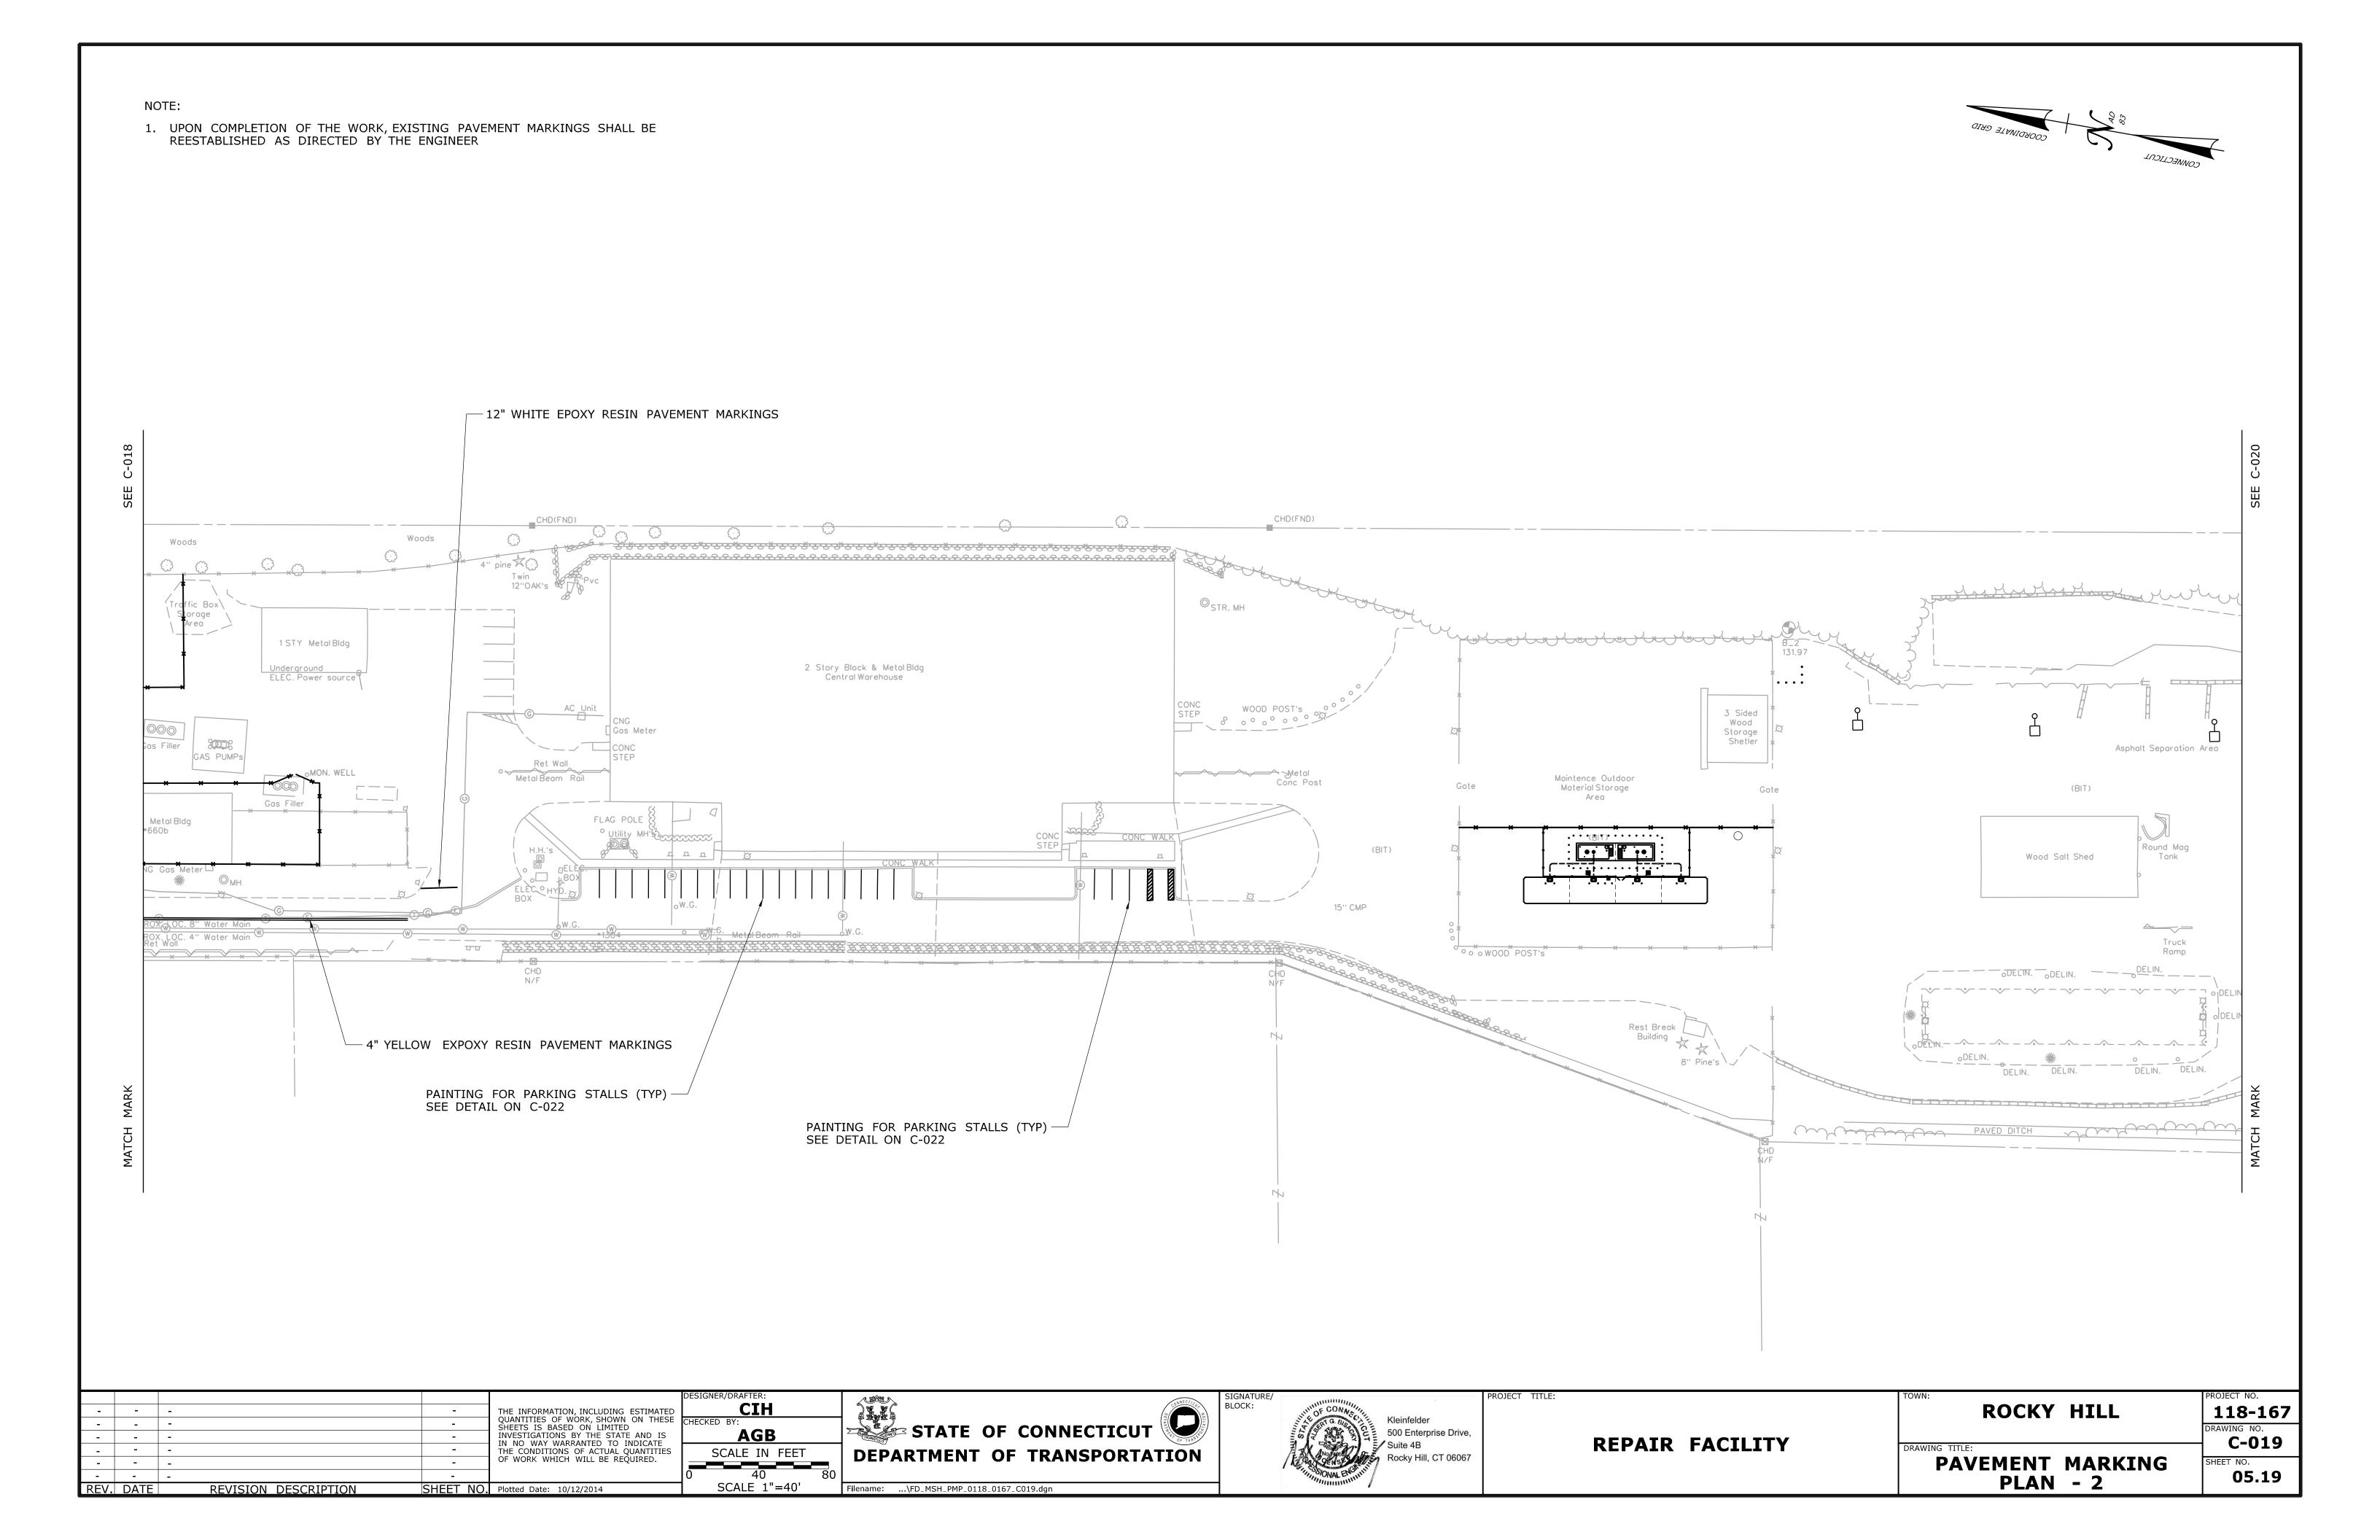

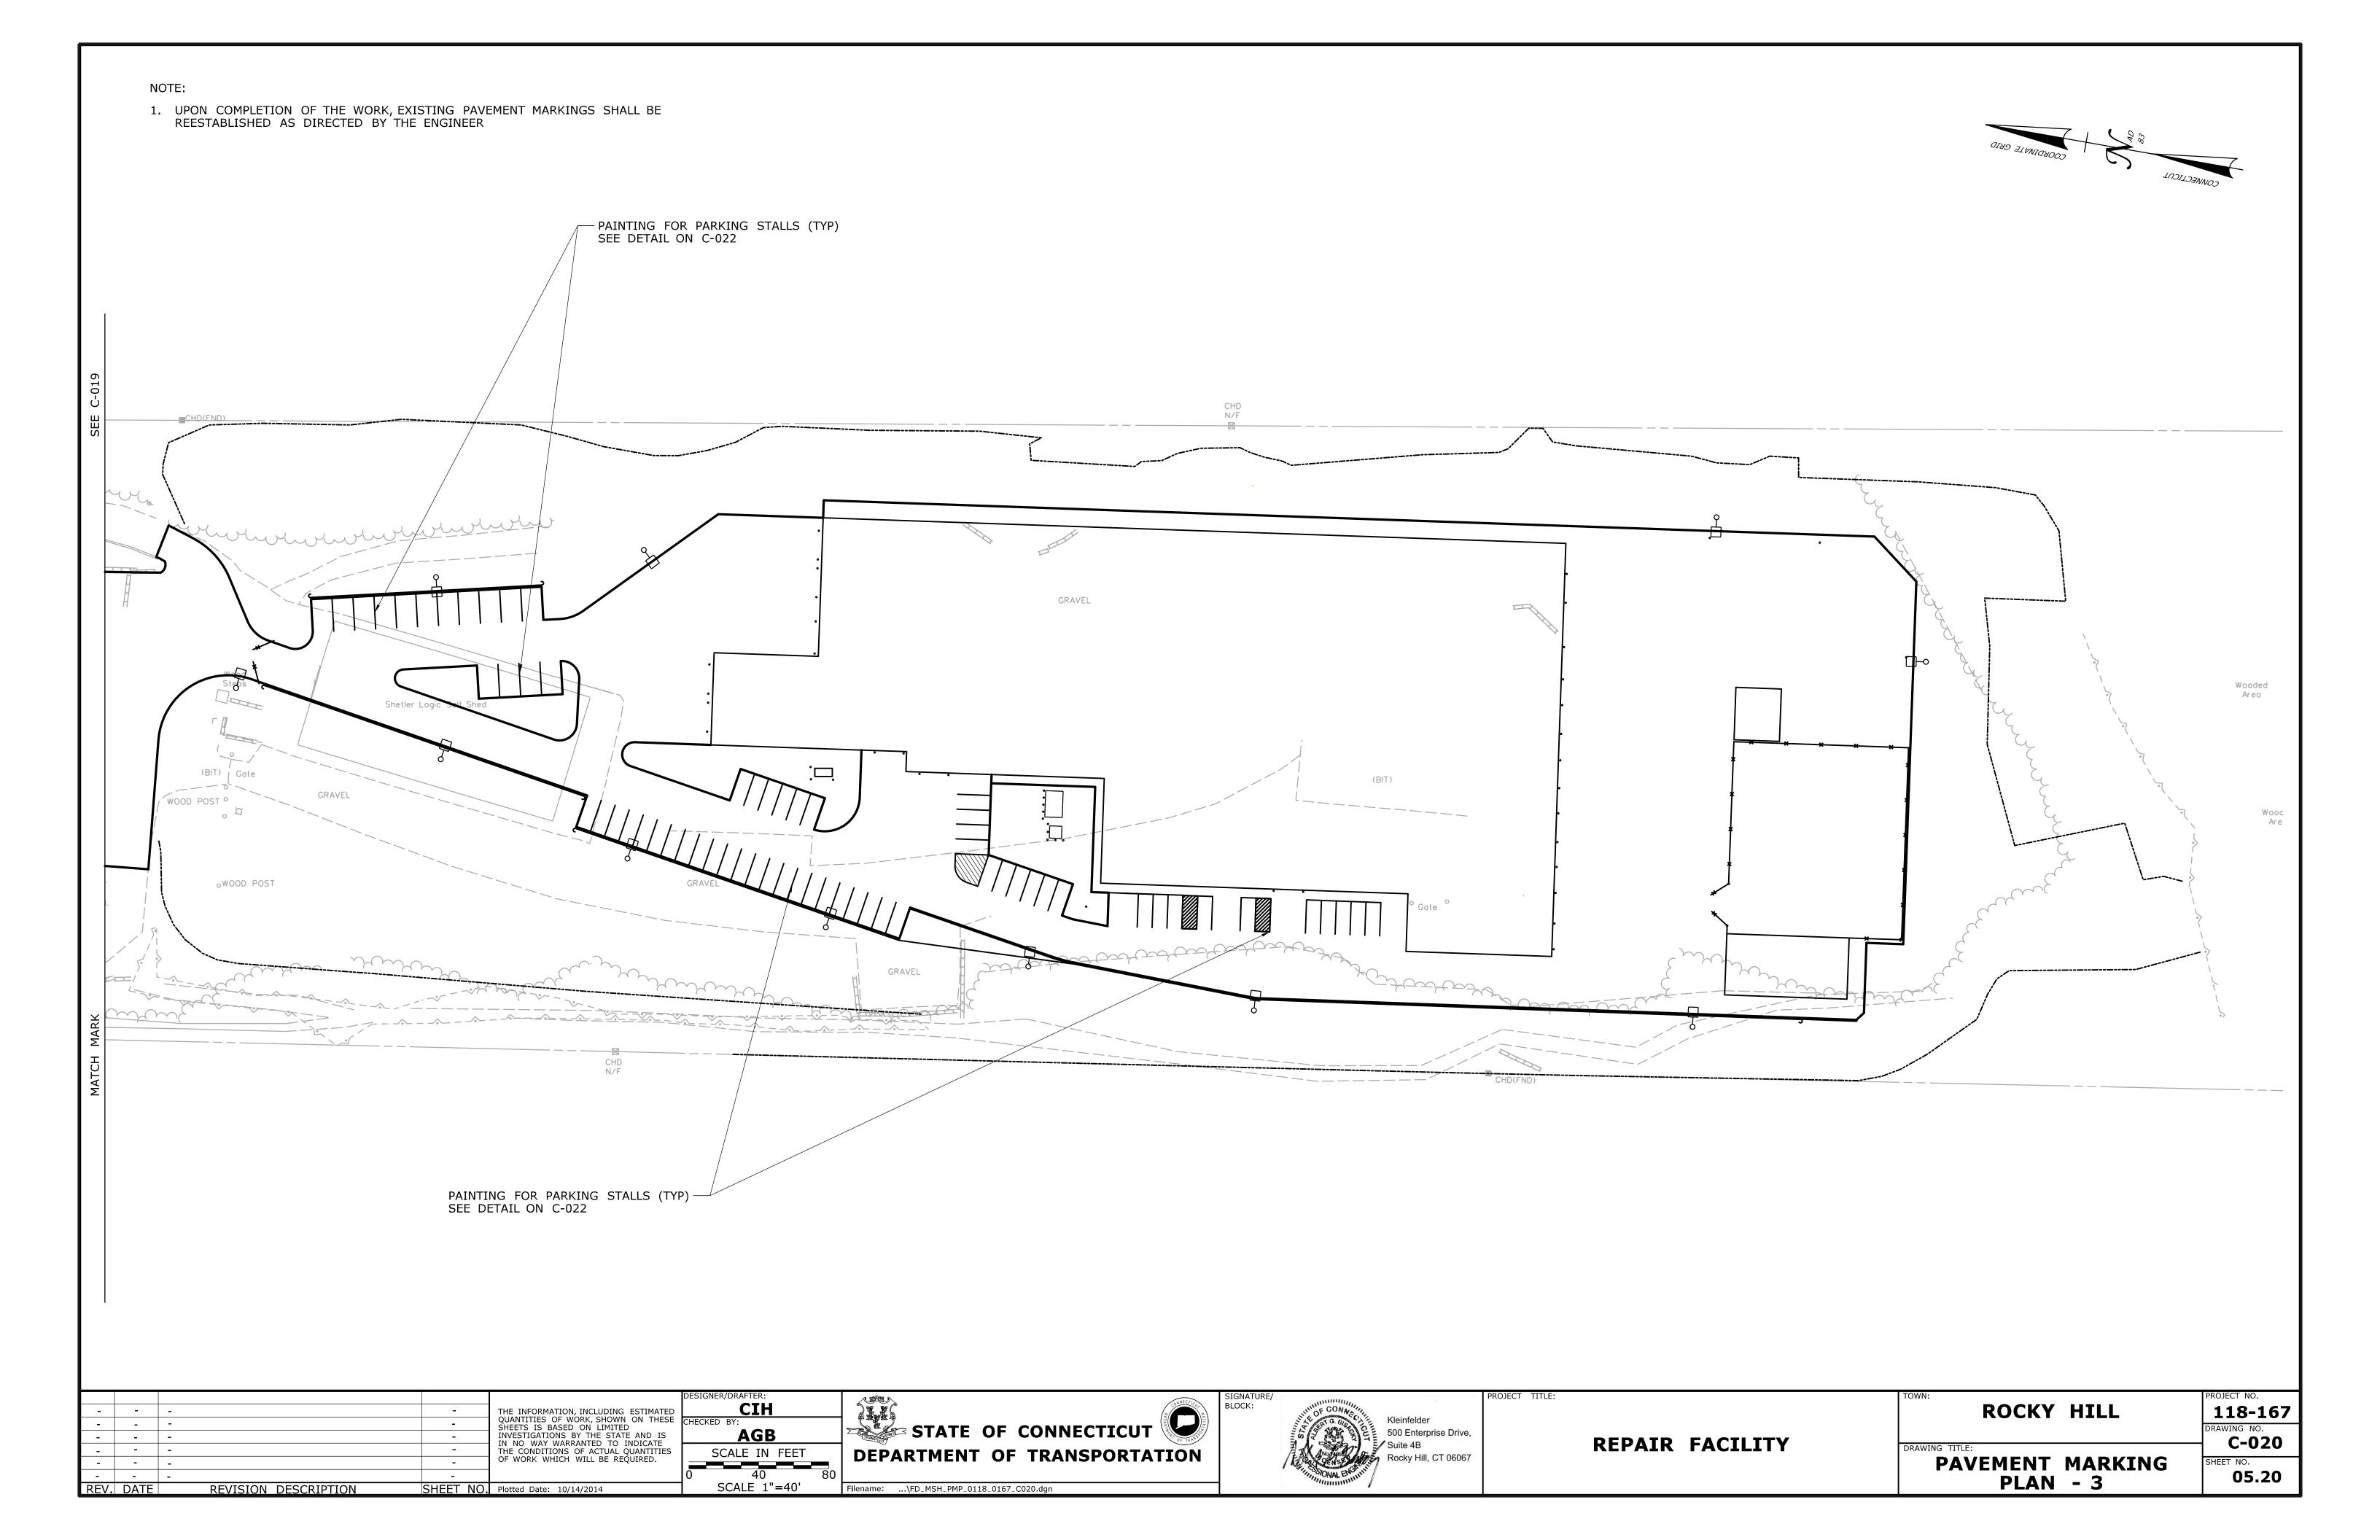

SLOPE PROTECTION DETAIL NOT TO SCALE

2"X2"X4' POST (SEE NOTES)

FILTER FABRIC

10' MAX.

2"X2"X3' WOOD OR METAL STAKE

HAYBALE (TYP.)

EXISTING GRADE

1' MIN
(TYP.)

BOTTOM OF 6" TRENCH

MIN (TYP.)


SECTION A-A


NOTES:

- 1. FABRIC TO BE ATTACHED TO POSTS WITH STAPLES.
- 2. FABRIC TO BE UV RESISTANT POLYPROPYLENE WITH A MINIMUM WEIGHT OF 2.5 OZ./S.Y.
- 3. USE SILT FENCE AND HAYBALES WHERE INDICATED OR AS DIRECTED BY THE ENGINEER.
- 4. WHERE HAYBALES ARE USED, TRENCH A MINIMUM OF 6" INTO EXISTING GRADE.
- 5. A MINIMUM OF TWO (2) WOODEN OR METAL STAKES PER HAYBALE. DRIVE STAKES A MIMIMUM OF 12" INTO GROUND.


SEDIMENTATION CONTROL SYSTEM

NOT TO SCALE

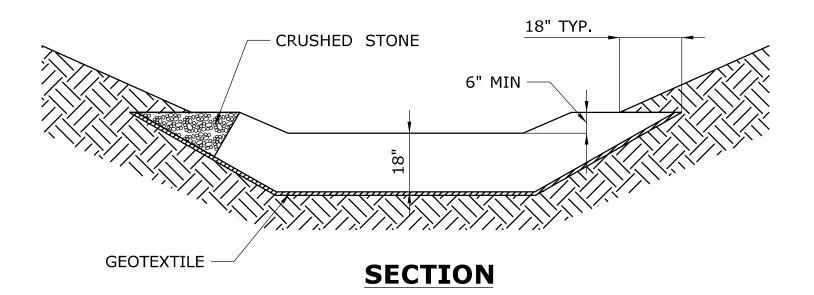

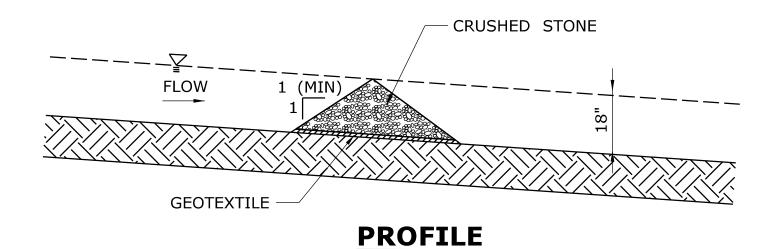

TEMPORARY CHECK DAM NOT TO SCALE

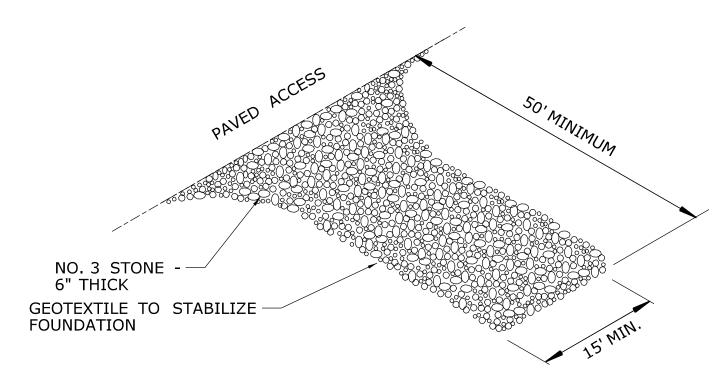

NOTES:


- 1. LOCATION TO BE APPROVED BY ENGINEER.
- 2. ADJACENT PAVED ACCESS TO BE CLEANED ONCE A DAY.
- 3. MUD MUST BE REMOVED FROM ALL CONSTRUCTION VEHICLES BEFORE ENTERING PUBLIC ROADS.
- 4. PROVISIONS MUST BE MADE TO INTERCEPT THE WASH WATER AND TRAP SEDIMENT BEFORE IT IS CARRIED OFF-SITE.

ANTI-TRACKING PAD NOT TO SCALE

-	-	-	-	THE INFORMATION, INCLUDING ESTIMATED
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-	-	-	-	IN NO WAY WARRANTED TO INDICATE THE CONDITIONS OF ACTUAL QUANTITIES
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-	-	-	-	
EV.	DATE	REVISION DESCRIPTION	SHEET NO.	Plotted Date: 10/12/2014


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SCALE AS	NOTED



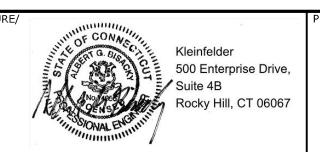

REPAIR	FACILITY

ROCKY HILL	PROJECT NO. 118-167
DRAWING TITLE:	C-021
CIVIL DETAILS - 1	SHEET NO. 05.21

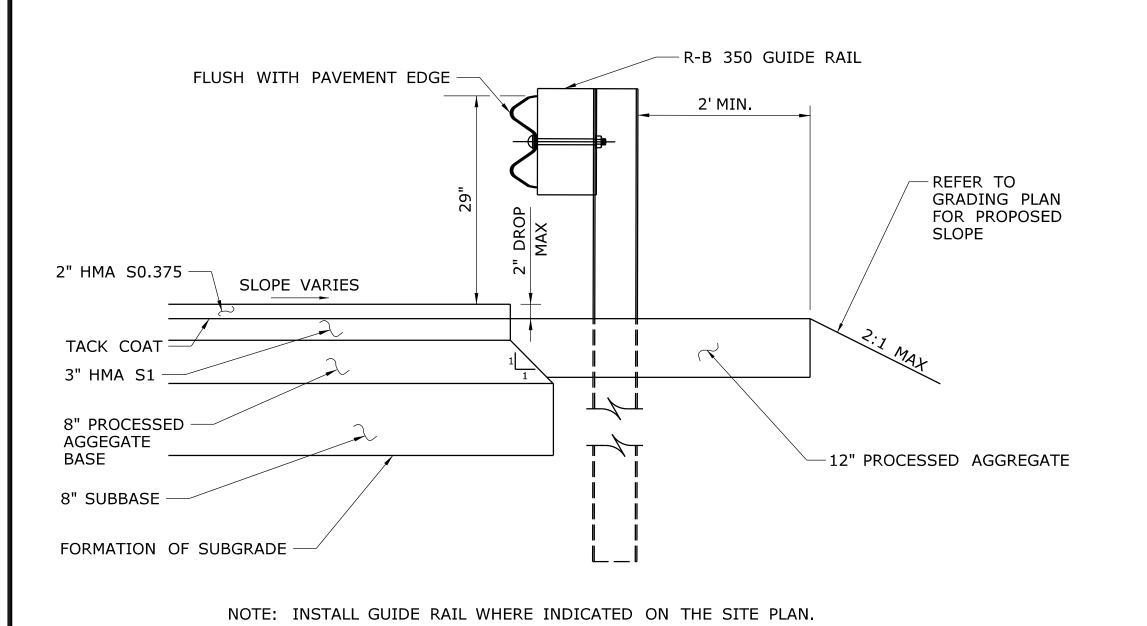

- 2" MILLING OF HMA 2" HMA S0.375 -TACK COAT EXISTING PAVEMENT

MILLING AND OVERLAY OF **BITUMINOUS CONCRETE PAVEMENT** NOT TO SCALE


-EXISTING GRASS AREA TACK COAT SLOPE VARIES -3" HMA S1 8" PROCESSED AGGEGATE BASE -8" SUBBASE BACKFILL IN 8" LIFTS AND COMPACT TO 90% DENSITY BURIED UTILITY WARNING TAPE 12" ABOVE DUCTBANK — FOAM BARRIER C OF CONDUITS $\stackrel{ullet}{--}$ REFER TO ELE-004 FOR DIMENSION


2" HMA S0.375

TYPICAL UTILITES DUCTBANK TRENCH

BITUMINOUS CONCRETE PAVEMENT


NOT TO SCALE

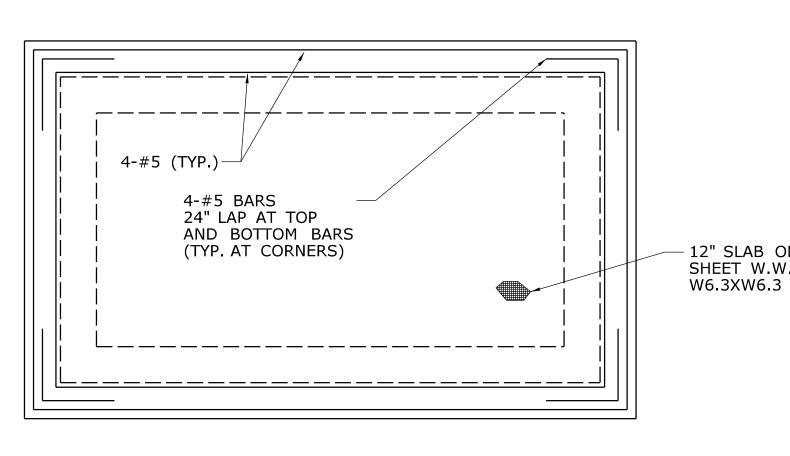


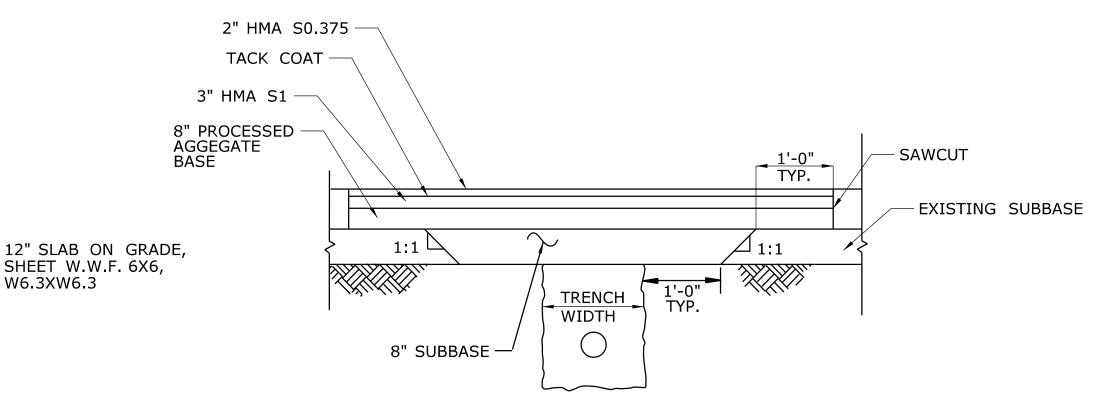

PAVEMENT REPAIR TRENCH DETAIL NOT TO SCALE

PLAN #3 STIRRUPS AT 12" O.C. ON ALL SIDES (TYP) - 1" x 1" CHAMFER (TYP.) FINISHED GRADE 6" GRANULAR FILL (TYP.) 3" COVER (TYP.)

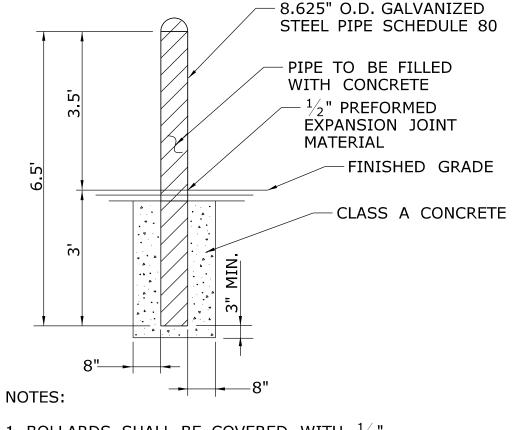

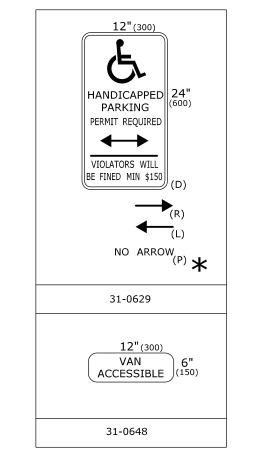

SECTION

NOTES:

REVISION DESCRIPTION

- | - | -

- | - | -

_ | - | -- | - | -

REV. DATE

- 1. CONCRETE SHALL BE CLASS F. REINFORCING SHALL BE EPOXY-COATED ASTM A615 GRADE 60.
- 2. DIMENSIONS FOR GENERATOR PAD SHALL FOLLOW MANUFACTURER'S RECOMMENDATIONS. COST OF THE GENERATOR PAD SHALL BE INCLUDED IN THE MLSI.
- 3. DIMENSIONS FOR WASTE OIL TANK PAD SHALL FOLLOW MANUFACTURER'S RECOMMENDATIONS. COST OF THE WASTE OIL TANK PAD SHALL BE INCLUDED IN THE MLSI.

CONCRETE PAD

NOT TO SCALE THE INFORMATION, INCLUDING ESTIMATED QUANTITIES OF WORK, SHOWN ON THESE SHEETS IS BASED ON LIMITED INVESTIGATIONS BY THE STATE AND IS IN NO WAY WARRANTED TO INDICATE THE CONDITIONS OF ACTUAL QUANTITIES OF WORK WHICH WILL BE REQUIRED.

SHEET NO. Plotted Date: 10/21/2014

SIGNER/DRAFTER:	
SAH	
CKED BY:	THE CTATE OF CONNECTION
AGB	STATE OF CONNECTICUT
	DEPARTMENT OF TRANSPORTAT
SCALE AS NOTED	

Filename: ...\FD_MSH_DET_0118_0167_C022.dgn

Kleinfelder 500 Enterprise Drive, Suite 4B
Rocky Hill, CT 06067

REP#

	ROCKY HILL	PROJECT NO. 118-167
AIR FACILITY	DRAWING TITLE:	——————————————————————————————————————
	CIVIL DETAILS - 2	SHEET NO. 05.22

1. BOLLARDS SHALL BE COVERED WITH $\frac{1}{4}$ " YELLOW POLYETHYLENE COVER.


2. TRIM BOLLARD COVER TO FIT. **BOLLARD PARKING SIGNS** NOT TO SCALE NOT TO SCALE

INSTALL ACCESSIBLE PARKING SIGN (CDOT SIGN #31-0629P) AND VAN ACCESSIBLE PARKING SIGN (CDOT SIGN #31-0648) 4" WHITE EPOXY RESIN-PAVEMENT MARKINGS OR CURB 8.5' 4" WHITE **EPOXY** RESIN **PAVEMENT** MARKINGS

1. WHERE SIDE OR END OF PARKING STALL IS BORDERED BY CURBING, PAINTED LINES ARE NOT REQUIRED.


2. WHERE PARKING STALL IS IN FRONT OF THE BUILDING, INSTALL ACCESSIBLE PARKING SIGN AND VAN ACCESSIBLE PARKING SIGN ON THE BUILDING.

PAINTING FOR PARKING STALLS

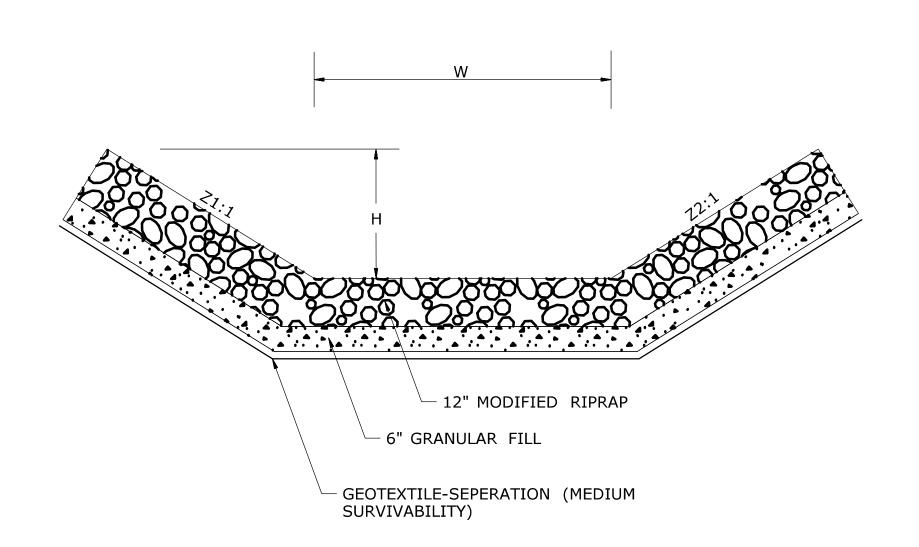

Ī	DITCH	W (FT)	H (FT)	Z1	Z2	SLOPE %
	DITCH #5	5	2.5 (MIN) 4.0 (MAX)	3	3	1.44%
	DITCH #7	6	2.0	2	2	0.129%
	DITCH #8	10	2.5	3	3	0.129%

RIPRAP LINED DITCH NOT TO SCALE

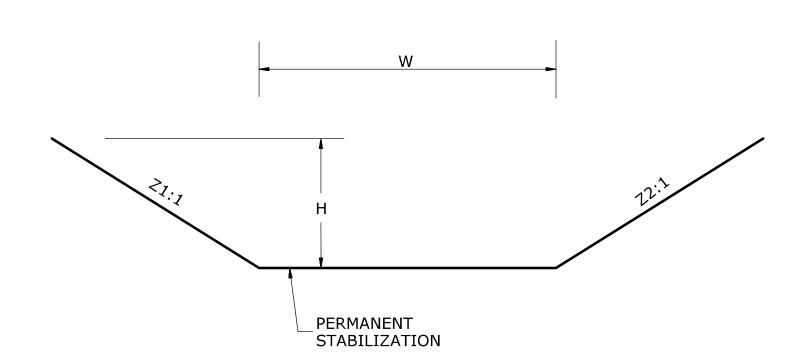


DITCH	W (FT)	H (FT)	Z1	Z2	SLOPE %
DITCH #2	0 (V-CHANNEL)	2.5 (MIN) 3.0 (MAX)	3	3	0.80%
DITCH #6	5	2.0	3	3	2.24%

GRASS LINED DITCH NOT TO SCALE

BASE PLATE FINISHED GRADE 2" SEALANT SAND-FILLED FOUNDATION TUBE 3500 PSI CONCRETE FOOTING HARDWOOD WEDGES-4 AT TOP, 4 AT BOTTOM 3/4" x 16" DIA. BASE PLATE WELD TO FOUNDATION TUBE 8" x 3/4" SECONDARY PLATE

FLAGPOLE FOOTING

NOT TO SCALE

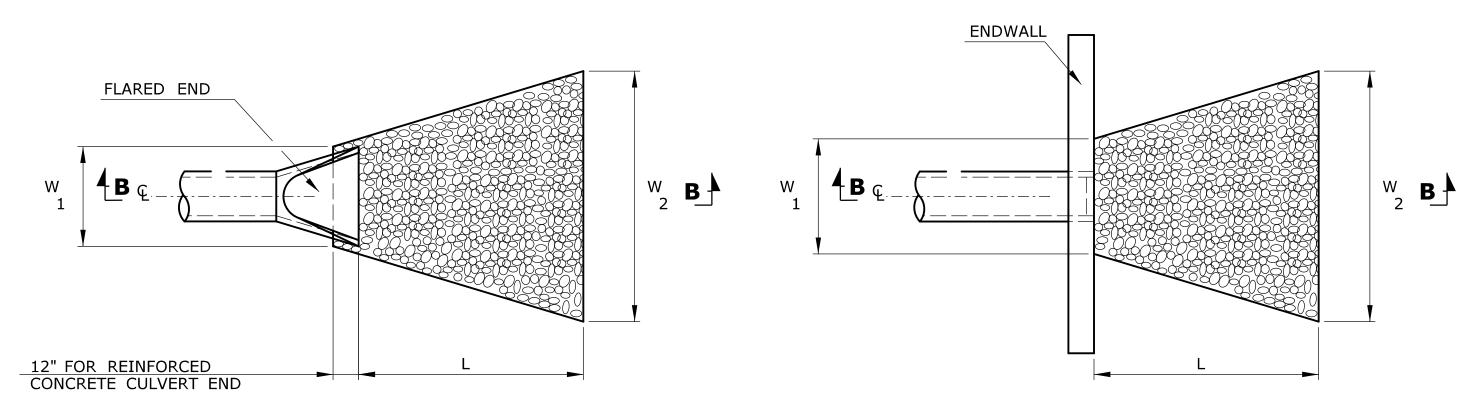

FLARED END PLAN VIEW

CULVERT END L 12" FOR FLARED END 6" GRANULAR FILL 12" MODIFIED RIPRAP


ENDWALL PLAN VIEW

OUTFALL	W1 (FT)	W2 (FT)	L (FT)
OUTFALL #1	3.75	8.25	11.50
OUTFALL #2	3.75	8.25	6.50
OUTFALL #3	3.75	11.50	11.00
OUTFALL #4	3.75	5.00	5.00
OUTFALL #5	3.75	7.00	8.50

SECTION B-B


RIPRAP APRON

			DESIGNER/DRAFTER:	NNECT.	SIGNATURE/	PROJECT TITLE:	TOWN:	PROJECT NO.
	-	THE INFORMATION, INCLUDING ESTIMATED	SAH		BLOCK:		ROCKY HILL	118-167
	-	UNITIES OF WORK, SHOWN ON THESE SHEETS IS BASED ON LIMITED	CHECKED BY:	STATE OF CONNECTICUT	Kleinfelder 500 Enterprise Drive,			DRAWING NO.
	-	INVESTIGATIONS BY THE STATE AND IS	AGB	STATE OF CONNECTICUT	500 Enterprise Drive,	REPAIR FACILITY		C-023
	-	THE CONDITIONS OF ACTUAL QUANTITIES		DEPARTMENT OF TRANSPORTATION	Suite 4B	KEPAIR FACILITY	DRAWING TITLE:	<u> </u>
	-	OF WORK WHICH WILL BE REQUIRED.		DEPARTMENT OF TRANSPORTATION	Rocky Hill, CT 06067		CIVIL DETAILS - 3	SHEET NO.
	-		SCALE AS NOTED		William Committee			05.23
REV. DATE REVISION DESCRIPTION	SHEET NO	Plotted Date: 10/12/2014	7	Filename:\FD_MSH_DET_0118_0167_C023.dgn	The state of the s			

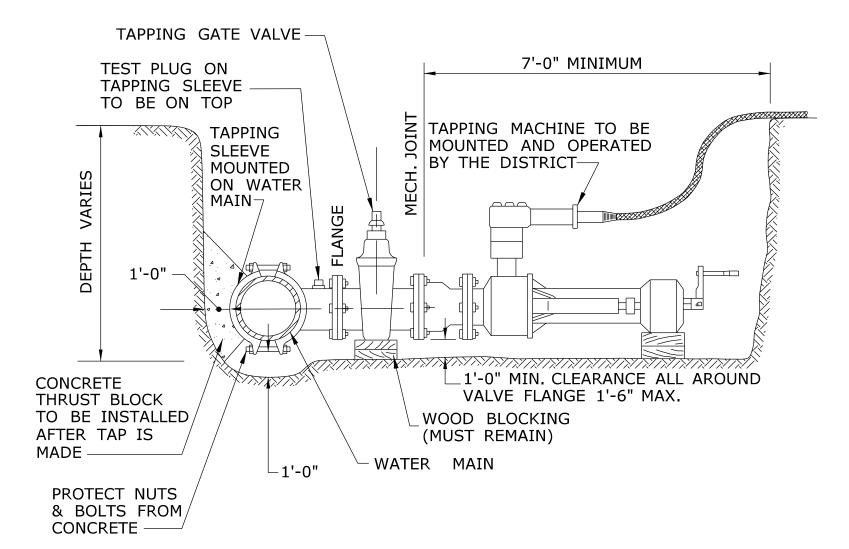


- 1. TAPPING SLEEVE & TAPPING GATE VALVE TO BE INSTALLED ON WATER MAIN BY THE CONTRACTOR. THE DISTRICT WILL TEST INSTALLATION PRIOR TO MAKING TAP. NO TAP WILL BE MADE IF THERE IS NO TEST PLUG.
- 2. TAPPING GATE VALVE TO HAVE HAND OF OPERATION AS DIRECTED BY THE DISTRICT. IF VALVE HAND OF OPERATION IS NOT CORRECT, NO TAP WILL BE MADE.
- 3. TRENCH TO BE DEWATERED AND IN COMPLIANCE WITH OSHA REQUIREMENTS FOR TRENCH EXCAVATION.


4-INCH TO 12-INCH TAP ON WATER MAIN

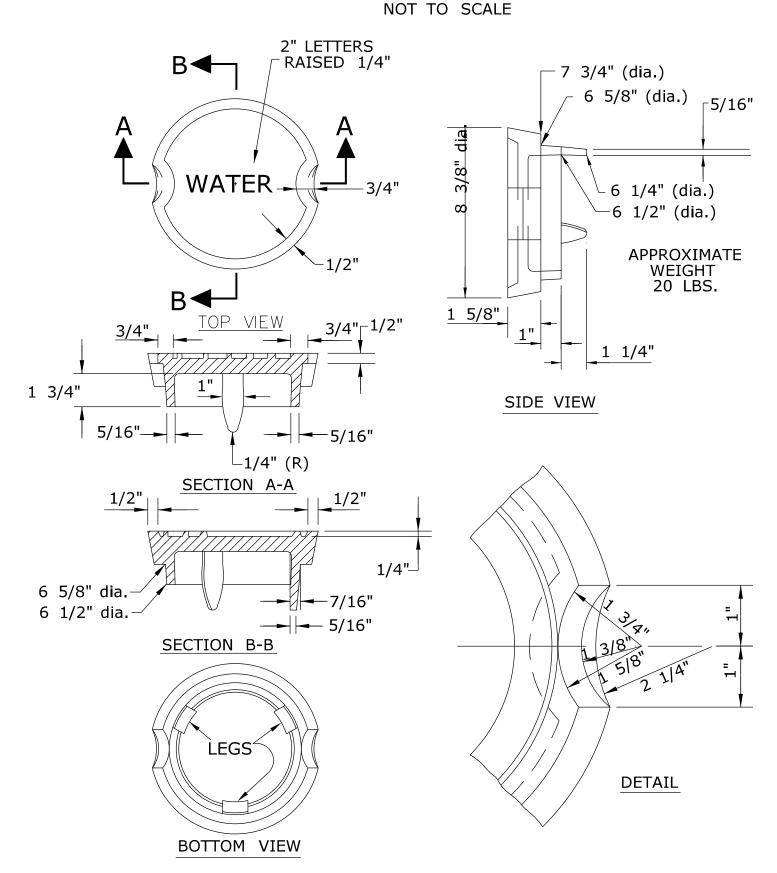

CAST IRON GATE BOX COVER

NOT TO SCALE

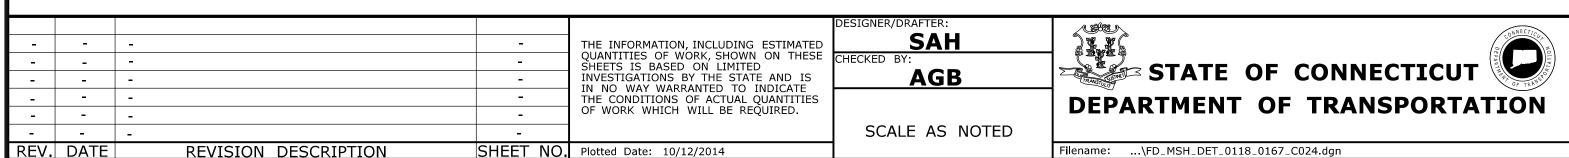

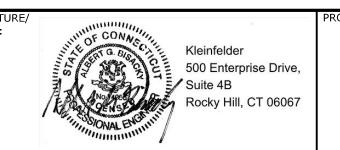



ROCKY HILL

ROCKY HILL

DRAWING TITLE:

WATER MAIN
DETAILS - 1

PROJECT NO.


118-167

DRAWING NO.


C-024

SHEET NO.

05.24

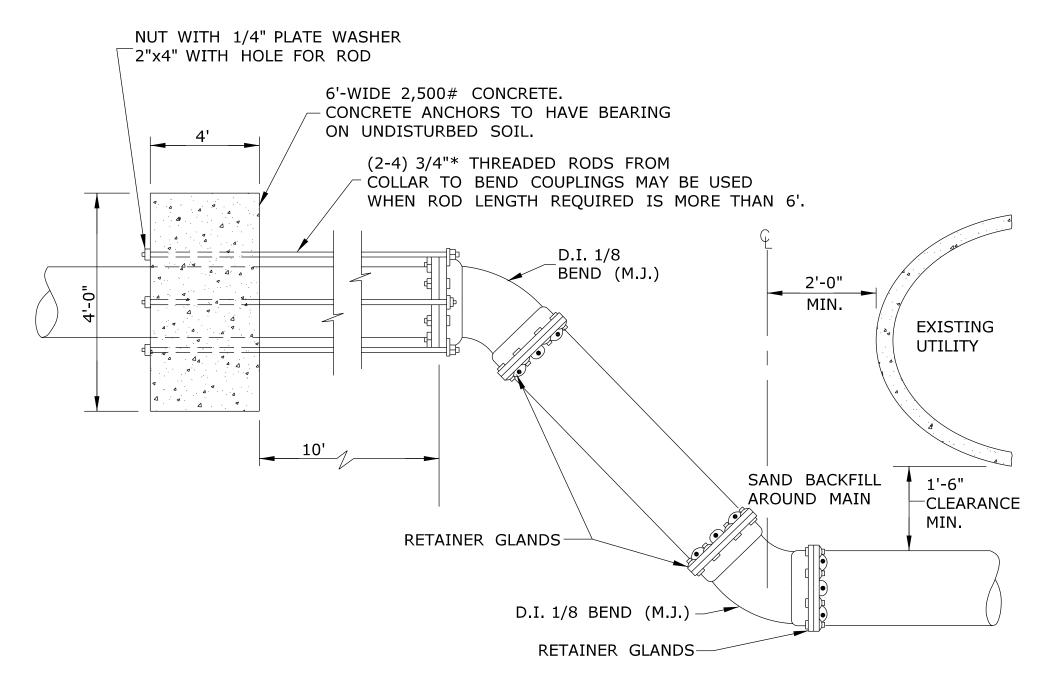


TYPICAL OFFSET

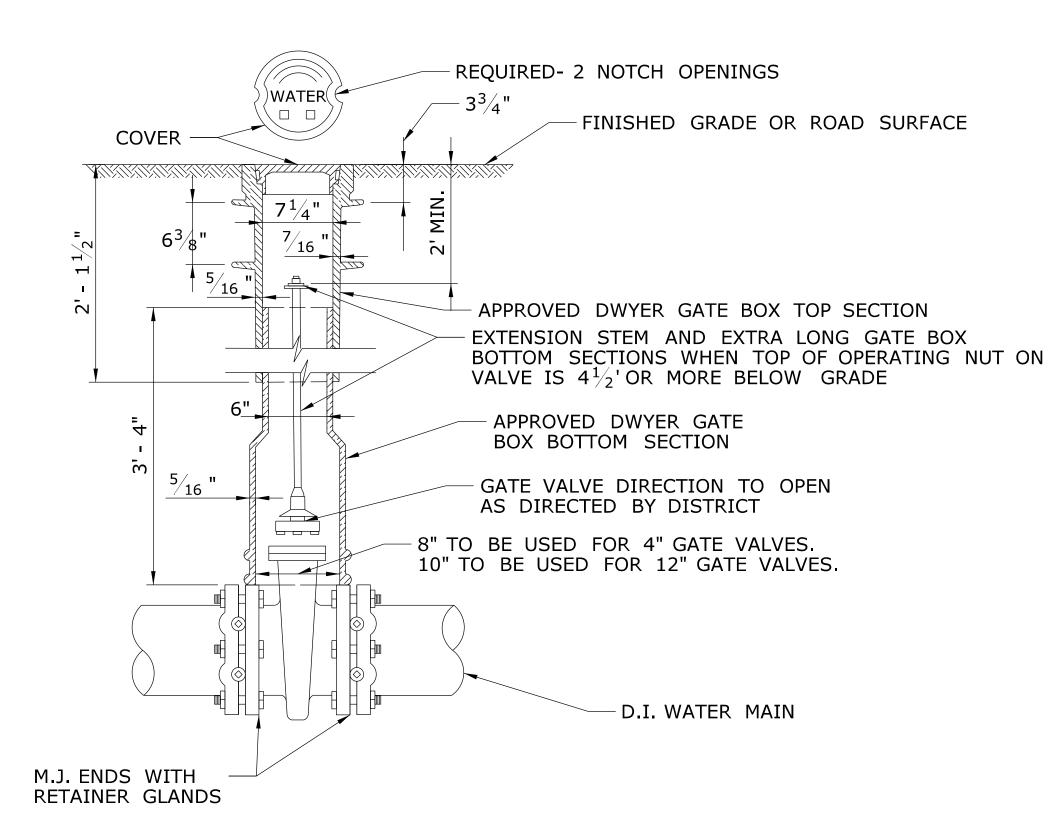


STANDARD GATE BOX AND TYPICAL GATE VALVE INSTALLATION

NOT TO SCALE

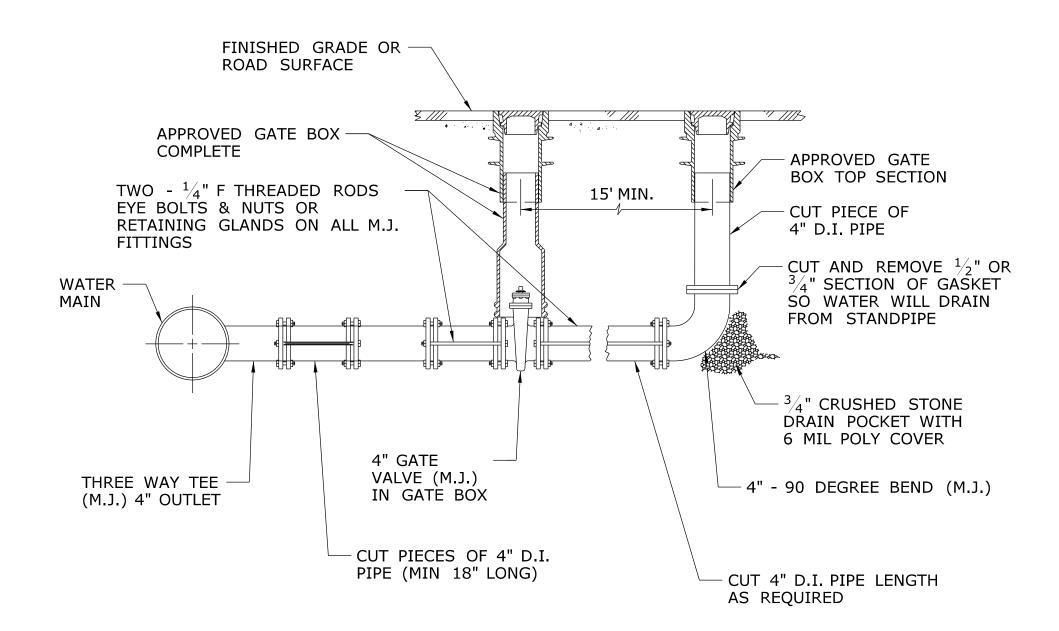

4" BLOW-OFF ASSEMBLY


NOT TO SCALE

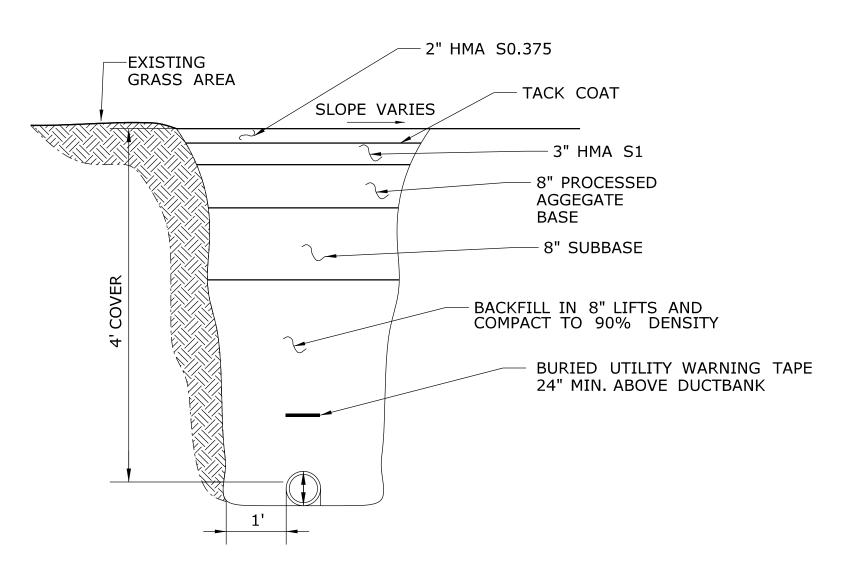

TYPICAL WATER MAIN TRENCH

NOT TO SCALE

3/4" THREADED RODS W/-NUTS AND WASHERS 24" TYPICAL LENGTH 12" MIN LENGTH - WASHER ALL LACING RODS SHALL EYE BOLTS RECEIVE TWO-COATS OF RUST INHIBITING PAINT AFTER ASSEMBLY DETAIL PUSH ON JOIT PIPE ANSI/AWWA C151/A EBBA IRON INC SERIES -21.11-80 D.I. CLASS 54 800 RETAINER GLAND APPROVED EQUAL TEE BUTS/NUTS -SEE DETAIL ABOVE -M.J. FITTING ANSI/AWWA -C110-77A 21.10 SET SCREWS M.J. FOLLOWER GLAND -WITH BOLTS — M.J. RETAINER GLAND └─ M.J. RETAINER GLAND USE EYE-BOLTS, NUTS & WASHER M.J. RETAINER GLAND -THRUST RESTRAINT-RESTRAINED 2 PUSH-ON JOINT RESTRAINT USING MECHANICAL JOINT RETAINER GLANDS JOINT METHODS AND LACING (1) MECHANICAL JOINT RETAINER GLANDS (3) PUSH-ON JOINT RETAINER GLANDS TYPICAL RESTRAINED JOINTS NOT TO SCALE

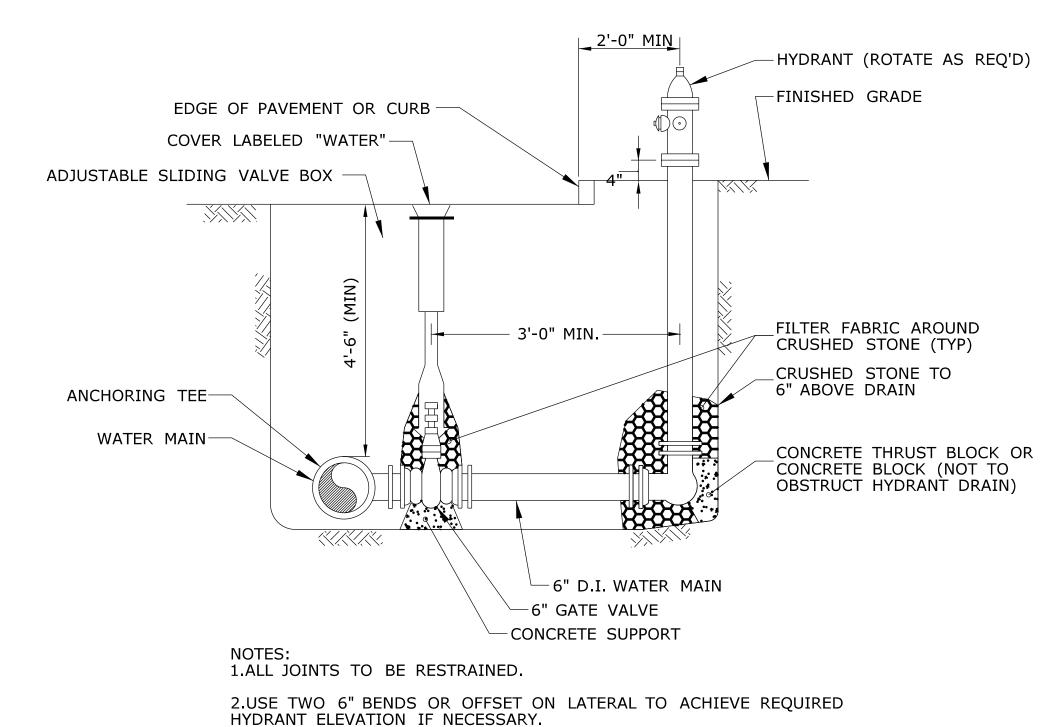


HYDRANT AND VALVE DETAIL

3.IF VALVE BOX IS NOT IN PAVED AREA PROVIDE CONCRETE COLLAR.


	DESIGNER/DRAFTER:	ANNECTA S		PROJECT TITLE:	TOWN:	PROJECT NO.
	THE INFORMATION, INCLUDING ESTIMATED SAH	CONNECTICAL STATE OF THE PROPERTY OF THE PROPE	BLOCK: OF CONNECTION		ROCKY HILL	 118-167
	SHEETS IS BASED ON LIMITED CHECKED BY:	STATE OF CONNECTICUT	Kleinfelder			DRAWING NO.
	INVESTIGATIONS BY THE STATE AND IS IN NO. WAY WARRANTED TO INDICATE AGB	STATE OF CONNECTICOT	500 Enterprise Drive,	DEDATO EACLITY		— C-025
	THE CONDITIONS OF ACTUAL QUANTITIES	DEPARTMENT OF TRANSPORTATION	Suite 4B	REPAIR FACLITY	DRAWING TITLE:	C-025
	OF WORK WHICH WILL BE REQUIRED.	DEPARTMENT OF TRANSPORTATION	Rocky Hill, CT 06067		WATER MAIN	SHEET NO.
	SCALE AS NOTED		MANUAL ENGINEER		DETAILS - 2	05.25
REV. DATE REVISION DESCRIPTION SHEET NO	Plotted Date: 10/14/2014	Filename:\FD_MSH_DET_0118_0167_C025.dgn	, million /		DETAILS - Z	

- 1. ALL CONSTRUCTION SHALL BE IN ACCORDANCE WITH METROPOLITAN DISTRICT STANDARDS AND SPECIFICATIONS.
- 2. THE SANITARY SEWER SHALL BE CONSTRUCTED UNDER A DEVELOPER'S PERMIT AGREEMENT BETWEEN (NAME AS APPEARS ON CERTIFICATE OF TITLE) AND THE METROPOLITAN DISTRICT, AND SHALL BE BUILT BY A LICENSED DRAIN LAYER UNDER PERMIT BY AND UNDER THE SUPERVISION OF THE DIRECTOR OF ENGINEERING AND PLANNING OR THEIR DESIGNEE.
- 3. "CALL BEFORE YOU DIG" THE CONTRACTOR IS HEREBY REMINDED THAT TITLE 16, CHAPTER 293 OF THE CONNECTICUT GENERAL STATUTES REQUIRES NOTIFICATION OF THE UTILITY COMPANIES OF PENDING EXCAVATION AT OR NEAR PUBLIC UTILITIES. THE CONTRACTOR SHALL CALL 1-800-922-4455 AT LEAST 48 HOURS PRIOR TO BEGINNING THE EXCAVATION.
- 4. SANITARY SEWERS ARE FOR SANITARY SEWAGE ONLY. ALL STORM WATER, COOLING WATER, AND SUBSOIL DRAINAGE ARE EXCLUDED FROM SANITARY SEWERS BY DISTRICT ORDINANCES.
- 5. SANITARY SEWER DISCHARGES MUST MEET ALL APPLICABLE STATE, FEDERAL, METROPOLITAN DISTRICT AND LOCAL REGULATIONS. THIS MAY INCLUDE, BUT IS NOT LIMITED TO PERMITTING, SAMPLING AND REPORTING REQUIREMENTS.
- 6. SUBSOIL AND SURFACE DRAINAGE SHALL BE CONNECTED TO THE NEAREST STORM DRAIN OR WATERCOURSE, AS APPROVED BY THE APPROPRIATE AUTHORITY.
- 7. ALL FEDERAL AND STATE OSHA SAFETY STANDARDS MUST BE FOLLOWED DURING SEWER INSTALLATION AND TESTING, INCLUDING 29 CFR 1926.650 1926.652, THAT ADDRESS EXCAVATION WORK AND REQUIREMENTS FOR PROTECTIVE SYSTEMS.
- 8. THE CONTRACTOR SHALL FURNISH TO THE ENGINEER A MATERIALS LIST, FOR REVIEW AND APPROVAL, PRIOR TO THE INSTALLATION OF THE PROPOSED SEWER.
- 9. ELEVATIONS ARE BASED ON NAVD 88 DATUM.
- 10. ALL SEWER PIPE AND APPURTENANCES SHALL BE STAKED (SURVEYED) OUT BY A PROFESSIONAL SURVEYOR LICENSED IN THE STATE OF CONNECTICUT. THE SURVEY SHALL INCLUDE AN OFFSET LINE EVERY EVEN FIFTY FEET (50'0"), BENCHES AND CUT SHEETS.
- 11. ANY PROPOSED WATER MAINS SHALL BE INSTALLED AFTER THE SANITARY SEWER.
- 12. WHENEVER POSSIBLE THE SANITARY SEWER SHALL BE LOCATED A MINIMUM OF TEN FEET (10'0") HORIZONTALLY FROM ANY EXISTING OR PROPOSED WATER MAIN. WHEN LOCAL CONDITIONS PREVENT THIS A LESSER DISTANCE IS ALLOWED IF (A) THE WATER MAIN IS IN A SEPARATE TRENCH, OR (B) IT IS LOCATED IN THE SAME TRENCH TO ONE SIDE ON A BENCH OF UNDISTURBED EARTH WITH AT LEAST TWELVE INCHES (12"), AND PREFERABLY EIGHTEEN INCHES (18") HORIZONTAL SEPARATION BETWEEN THE EDGES OF THE SEWER PIPE AND THE WATER MAIN. IN EITHER CASE, THE BOTTOM OF THE WATER MAIN SHALL BE EIGHTEEN INCHES ABOVE THE CROWN OF THE SEWER PIPE.
- 13. ANY CONFLICT BETWEEN THE PROPOSED SANITARY SEWER, EXISTING OR PROPOSED UTILITIES AND/OR STORM DRAINS WILL BE RESOLVED AT THE EXPENSE OF THE DEVELOPER.
- 14. ROADWAYS REQUIRING FILL SHALL HAVE A MINIMUM OF THREE FEET (3'0") OF ACCEPTABLE FILL PLACED ABOVE THE TOP OF THE PROPOSED PIPE ELEVATION OR TO ESTABLISHED GRADE, AND COMPACTED TO 95% DENSITY PRIOR TO INSTALLATION OF THE SANITARY SEWER.
- 15. TRENCH BACKFILL UNDER ROADWAYS AND WALKWAYS SHALL BE BANK RUN GRAVEL, SAND, OR ACCEPTABLE NATURAL SOIL, SATISFACTORY TO THE TOWN, CITY AND/OR STATE AUTHORITY HAVING JURISDICTION.
- 16. PRIOR TO PLACING BACKFILL, THE CRUSHED STONE FOUNDATION AND THE STONE HAUNCHING ALONG THE MAIN SEWER PIPES AND LATERALS SHALL BE WRAPPED IN A DISTRICT APPROVED FILTER FABRIC AND SHALL BE LAPPED CLOSED AT THE TOP A MINIMUM OF ONE FOOT (1'0"). THE FILTER FABRIC SHALL BE PLACED UNDER THE CRUSHED STONE FOUNDATION FOR MANHOLES AND EXTENDED ABOVE THE PIPE.
- 17. AFTER PLACING APPROXIMATELY TWO FEET (2'0") OF BACKFILL OVER ALL SEWER PIPING, THE CONTRACTOR SHALL PLACE A SIX-INCH WIDE STRIP OF DURABLE, NON-DETECTABLE COLOR CODED (GREEN FOR SANITARY SEWER AND STORM SEWER) UNDERGROUND UTILITY LOCATION TAPE IMPRINTED WITH AN APPROPRIATE WARNING INDICATING THE PRESENCE OF THE BURIED UTILITY CONDUIT.
- 18. THE CONTRACTOR IS RESPONSIBLE, AT HIS OWN EXPENSE, FOR VERIFYING FIELD COMPACTION OF BACKFILL UTILIZING AASHTO T180 METHOD D. TEST RESULTS MAY BE REQUIRED BY THE METROPOLITAN DISTRICT.
- 19. TEMPORARY AND PERMANENT PAVING RESTORATION SHALL BE IN ACCORDANCE WITH DISTRICT AND/OR TOWN AND/OR STATE SPECIFICATIONS.
- 20. THE SEWER LINE SHALL BE TESTED FOR LEAKAGE USING LOW PRESSURE AIR IN ACCORDANCE WITH SPECIFICATIONS FURNISHED BY THE METROPOLITAN DISTRICT. ANY SECTION OF PIPELINE FAILING THE TEST SHALL BE REPAIRED OR REPLACED AND RETESTED BEFORE INDIVIDUAL BUILDING CONNECTIONS WILL BE PERMITTED
- 21. CLOSED CIRCUIT TELEVISION (CCTV) INSPECTION(S) SHALL BE DONE BY THE CONTRACTOR UPON COMPLETION OF THE SEWER, AND AGAIN AT THE END OF THE ONE-YEAR MAINTENANCE PERIOD AT THE DEVELOPER'S EXPENSE. A DISTRICT REPRESENTATIVE SHALL BE PRESENT DURING THE INSPECTIONS.
- 22. ALL SANITARY SEWER LATERALS SHALL BE A MINIMUM OF SIX INCHES (6") IN DIAMETER AND SHALL BE INSTALLED AT NOT LESS THAN TWO PERCENT (2%) GRADE. THE MAXIMUM GRADE ALLOWED SHALL BE TEN PERCENT (10%). LATERALS TO THE EDGE OF THE RIGHT-OF-WAY OR EASEMENT SHALL BE BUILT IN CONJUNCTION WITH THE MAIN SEWER CONSTRUCTION.
- 23. APPROVAL FOR THE SEWER IS FOR THE MAIN LINE ONLY. CONNECTIONS FROM THE LATERALS AT THE EDGE OF THE RIGHT-OF-WAY OR THE EDGE OF THE EASEMENT TO THE BUILDING(S) SHALL BE CONSTRUCTED UNDER INDIVIDUAL HOUSE CONNECTION PERMITS ISSUED BY THE CUSTOMER SERVICE DEPARTMENT OF THE METROPOLITAN DISTRICT, LOCATED AT 60 MURPHY ROAD, HARTFORD, CONNECTICUT.

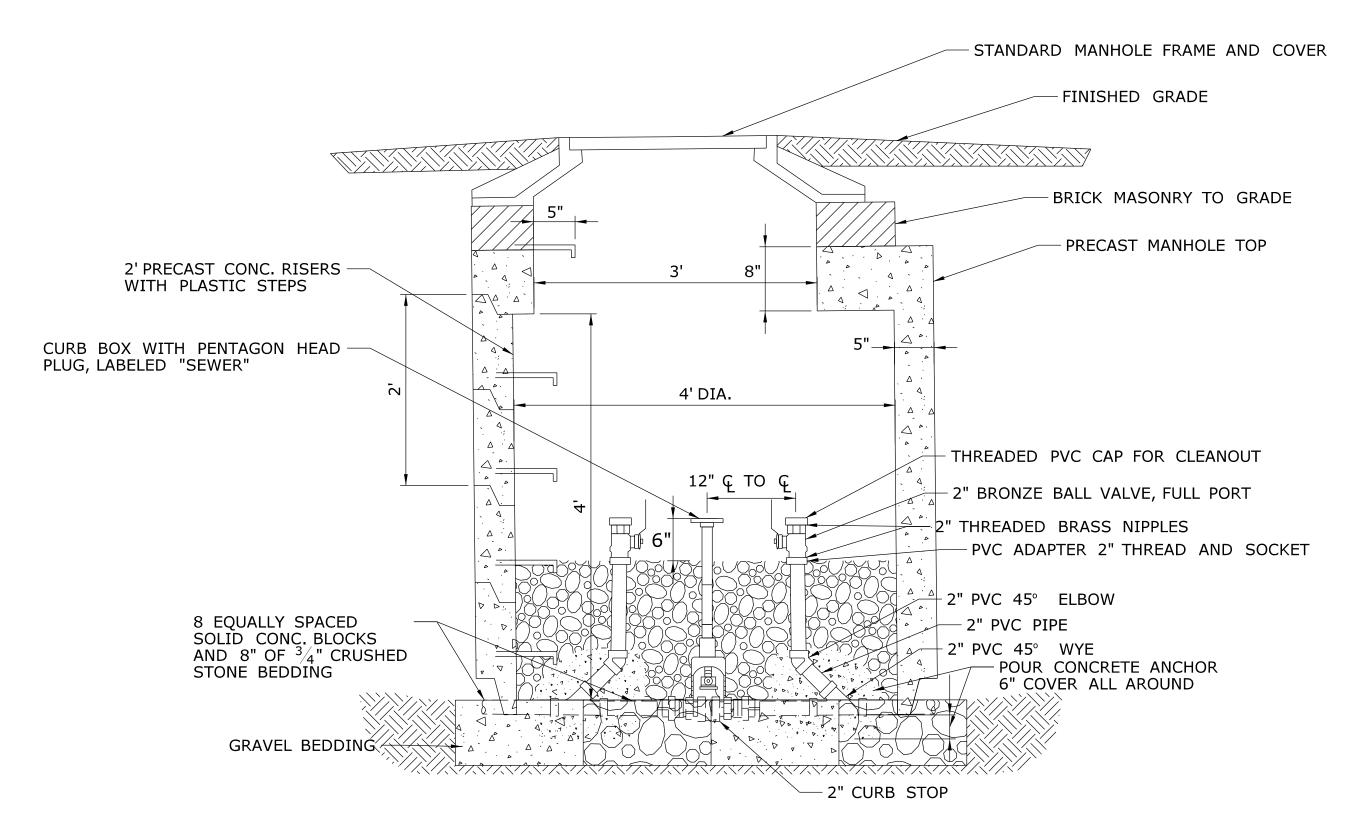

DETAIL OF SANITARY FORCE MAIN CLEAN-OUT & CURB STOP

NOT TO SCALE

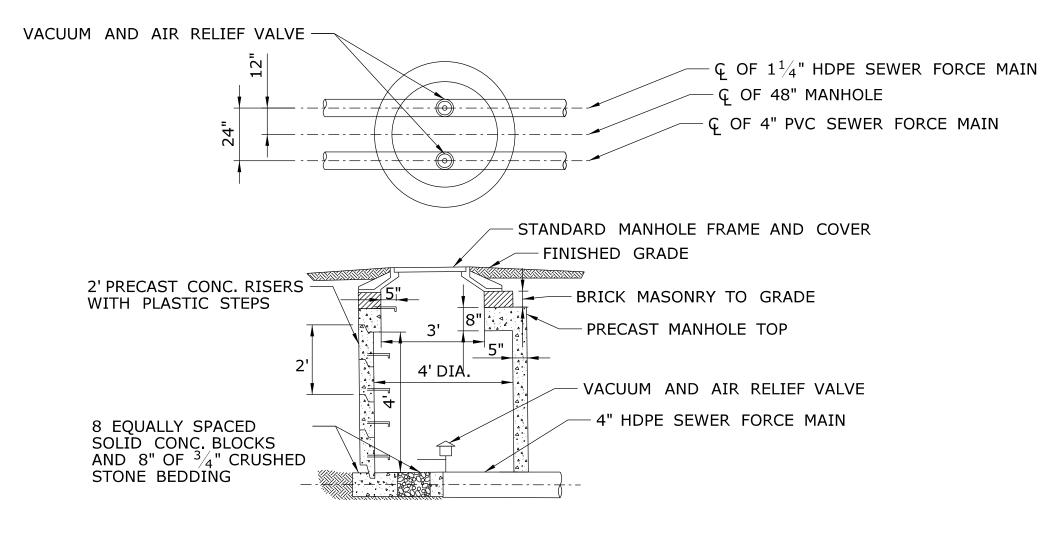

NOTES:

1. REINFORCING STEEL NOT SHOWN. STEEL REINFORCEMENT SHALL BE A.S.T.M. C-478.

2. CONCRETE MIN STRENGTH 4000 P.S.I. IN 28 DAYS. CONSTRUCTION JOINT SHALL BE SEALED WITH BUTYL RUBBER GASKET.

TYPICAL VACUUM AND AIR RELIEF VALVE MANHOLE NOT TO SCALE

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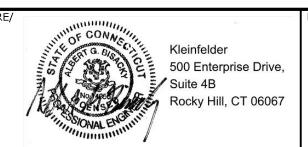
SHEET NO. Plotted Date: 10/11/2014

REVISION DESCRIPTION

REV. DATE

SAH **AGB**





ROCKY HILL

SANITARY SEWER

DETAILS - 1


118-167

C-026

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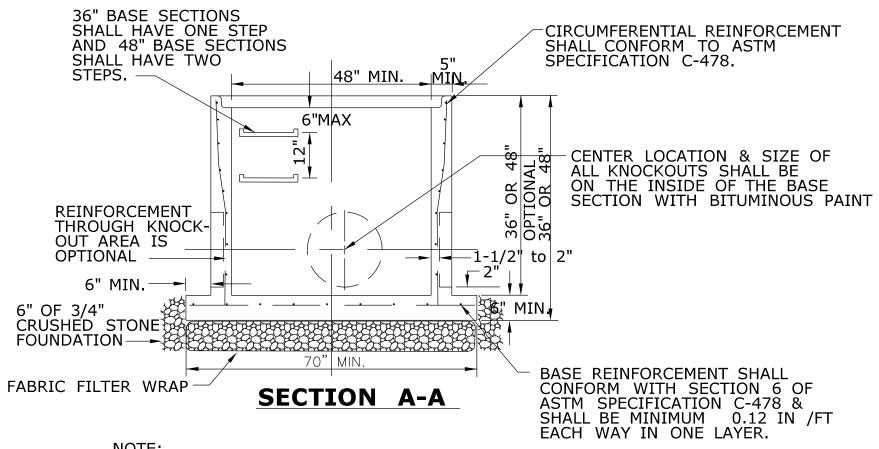
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SCALE AS NOTED Filename: ...\FD_MSH_DET_0118_0167_C026.dgn REPAIR FACILITY




PLAN

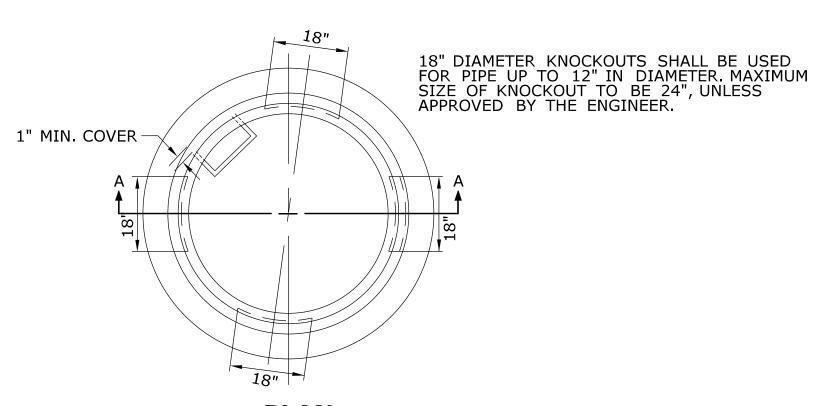EACH BASE SHALL HAVE FOUR KNOCKOUTS AS SHOWN. IF THE ENGINEER REQUIRES ADDITIONAL KNOCKOUTS FOR FUTURE CONNECTIONS, THESE ADDITIONAL KNOCK-OUTS BE BE DESIGNATED ON THE PLANS.



ALL JOINTS REQUIRED IN THE CONSTRUCTION OF THE MANHOLE SHALL BE MADE WITH BUTYL RUBBER GASKETS. GASKET MATERIAL SHALL CONFORM TO ASTM SPEC. C-443.

MINIMUM REQUIREMENTS FOR PRECAST MANHOLE BASE NOT TO SCALE

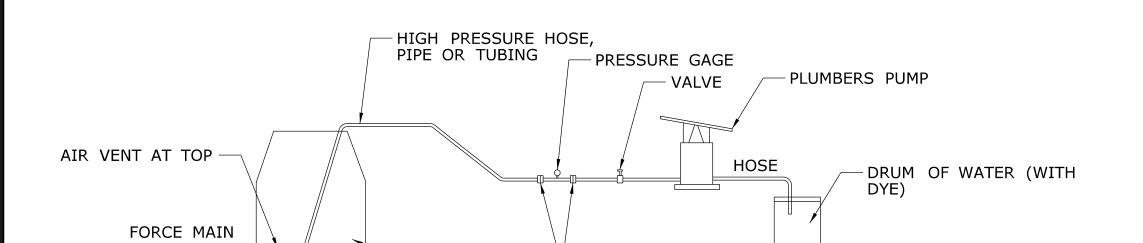


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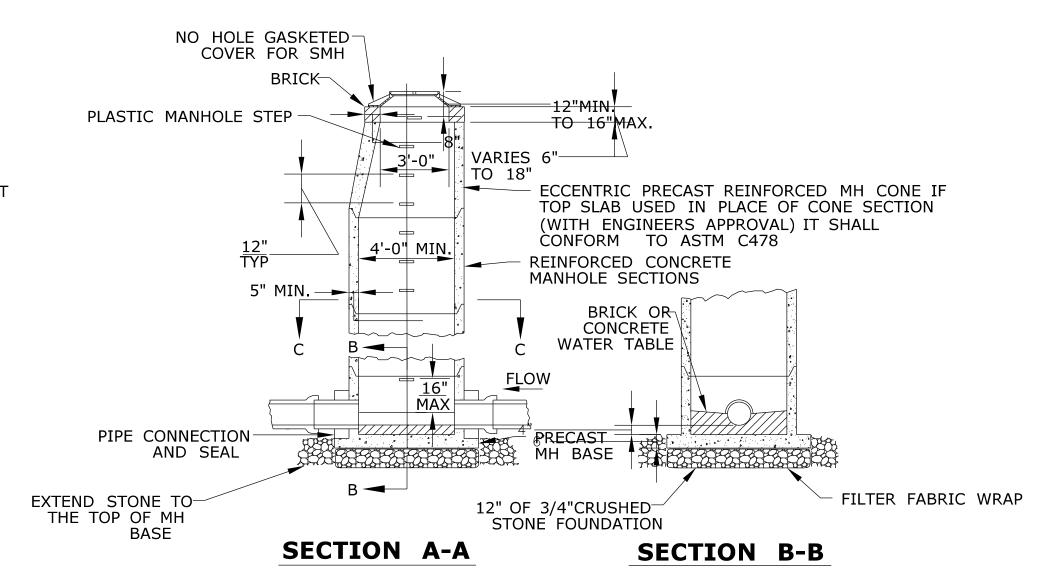
-DISCHARGE MANHOLE

SANITARY SEWER FORCE MAIN TESTING NOT TO SCALE

TEST PLATE

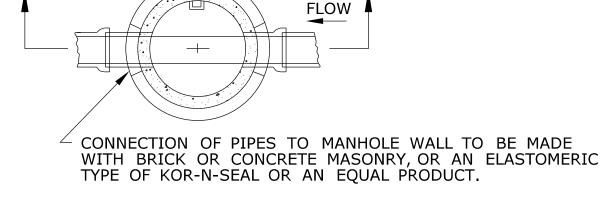


SECTION C-C



NOTES:

- 1. MAXIMUM SIZE OF PIPE TO BE INSTALLED IN A 4'-0" TYPE II MANHOLE TO
- 2. MAXIMUM DEPTH OF R.C. PIPE MANHOLES WITH 5" THICK WALL IS 30 FT.
- 3. BUTYL RUBBER GASKETS USED FOR JOINTS SHALL CONFORM TO ASTM SPEC. C433
- 4. ALL PRECAST MANHOLE BASES SHALL COMPLY WITH THE "MINIMUM REQUIREMENTS FOR 48" DIAMETER PRECAST MANHOLE BASE"

TYPICAL TYPE II PRECAST MANHOLE NOT TO SCALE

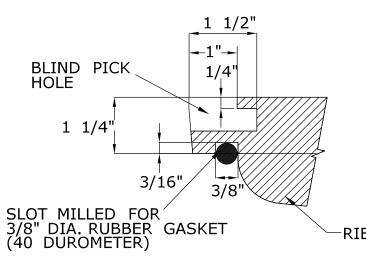

BLIND PICK HOLE


SELF SEALING (GASKET) COVER DETAIL

-23 3/4" 1 1/4" 2 1/2" SEE SELF SEALING (GASKET)

STANDARD MH COVER SECTION

COVER DETAIL

COVER WEIGHT: 175 LBS ≎3% LeBARON FOUNDRY CO., (LJ 105)

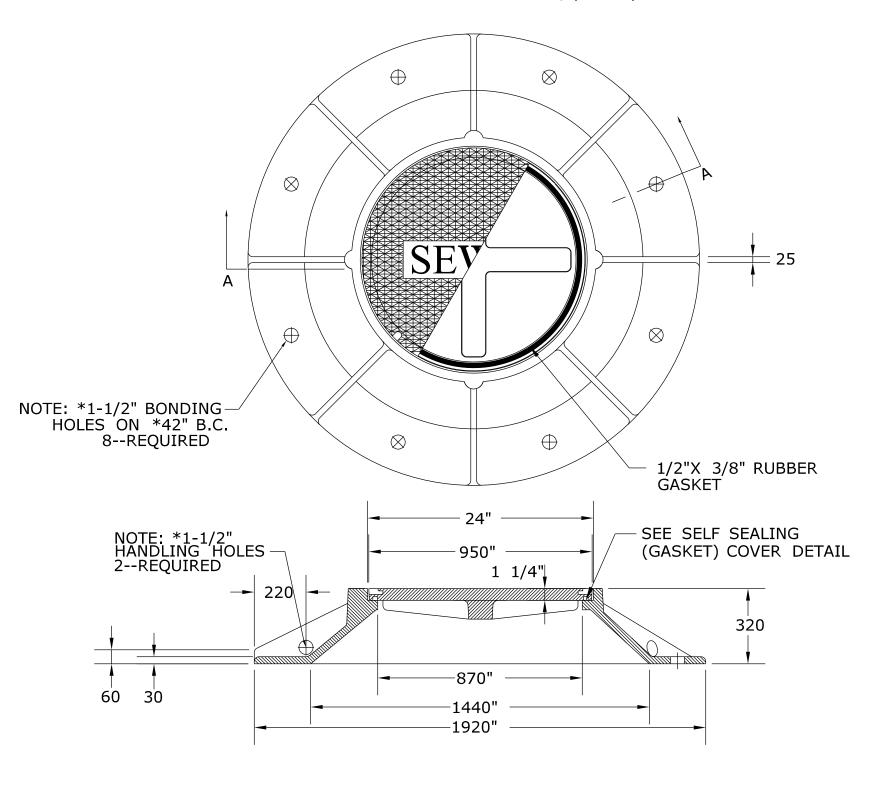

SECTION A-A

FRAME WEIGHT: 427 LBS ≎3%

SMH FRAME & COVER DETAIL NOT TO SCALE

NOTES: 1. BE SURE ALL TEST PIPE, HOSE AND FITTINGS ARE TIGHT AT THE JOINTS. CHECK JOINTS WITH SOAP SOLUTION.

2. BE SURE THE VALVE BETWEEN PRESSURE GAGE AND PUMP IS TIGHT: IF NOT, DISCONNECT AT PUMP AND CAP OR PLUG.


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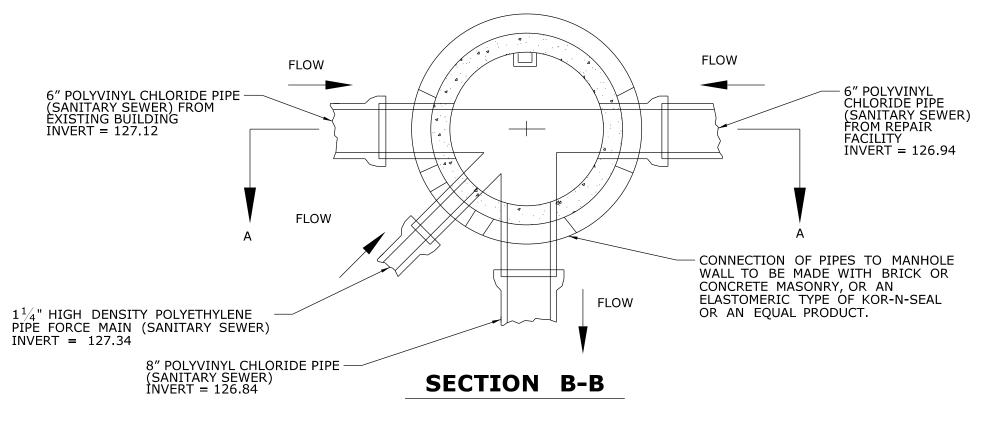
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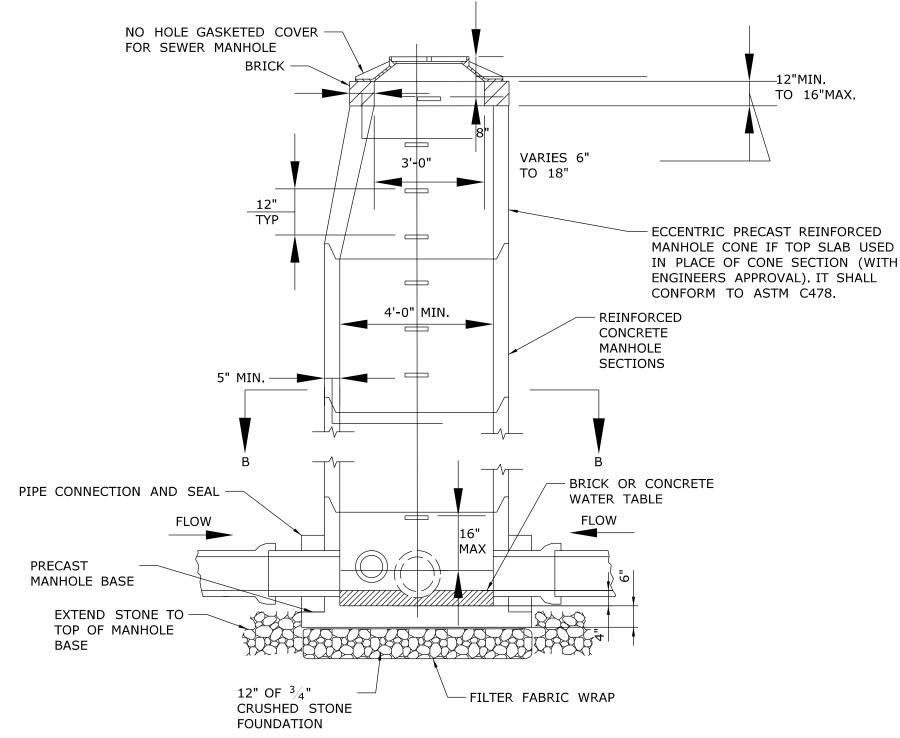
STATE OF CONNECTICUT **DEPARTMENT OF TRANSPORTATION**



REPAIR FACLITY

TOWN:	PROJECT NO.
ROCKY HILL	118-167
	DRAWING NO. C-027
DRAWING TITLE:	7 C-U2 /
SANITARY SEWER DETAILS - 2	SHEET NO. 05.27



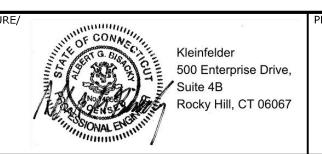


SECTION A-A

- 1. MAXIMUM DEPTH OF R.C. PIPE MANHOLES WITH 5" THICK WALL IS 30 FT.
- 2. BUTYL RUBBER GASKETS USED FOR JOINTS SHALL CONFORM TO ASTM SPEC. C433
- 3. ALL PRECAST MANHOLE BASES SHALL COMPLY WITH THE "MINIMUM REQUIREMENTS FOR 48" DIAMETER PRECAST MANHOLE BASE"


TYPE II PRECAST MANHOLE
BEFORE PUMPING STATION
(SANITARY SEWER)

NOT TO SCALE

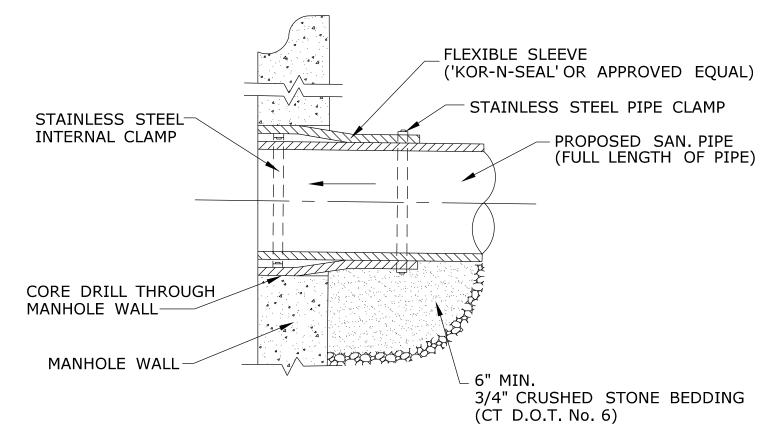

NOTE:
ALL STRAPS AND BOLTS TO BE STAINLESS STEEL

TYPICAL MANHOLE SLEEVE DETAIL

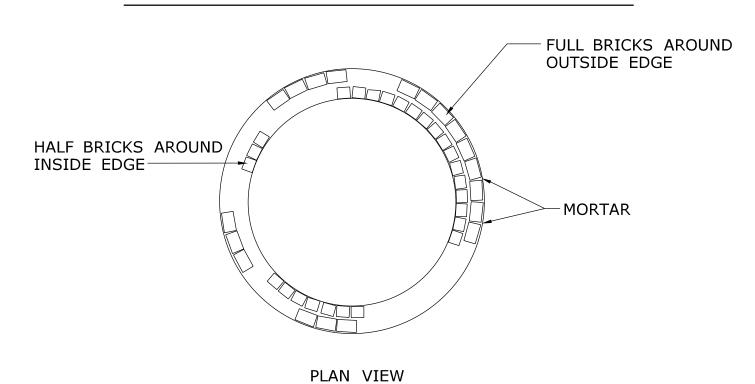


BRICK LEVELING COURSE FOR MANHOLE

NOT TO SCALE

3 1/8" 8 1/4" 1 3/8" 15 7/16"

COPOLYMER POLYPROPYLENE PLASTIC


NOT TO SCALE

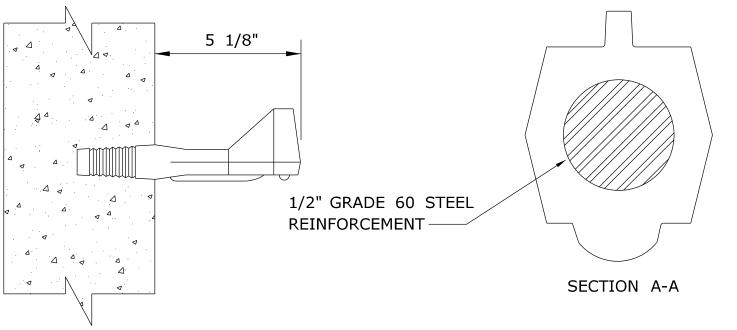

PLASTIC MANHOLE STEP

(FOR INSTALLATION IN PRE-CAST CONCRETE)

NOT TO SCALE

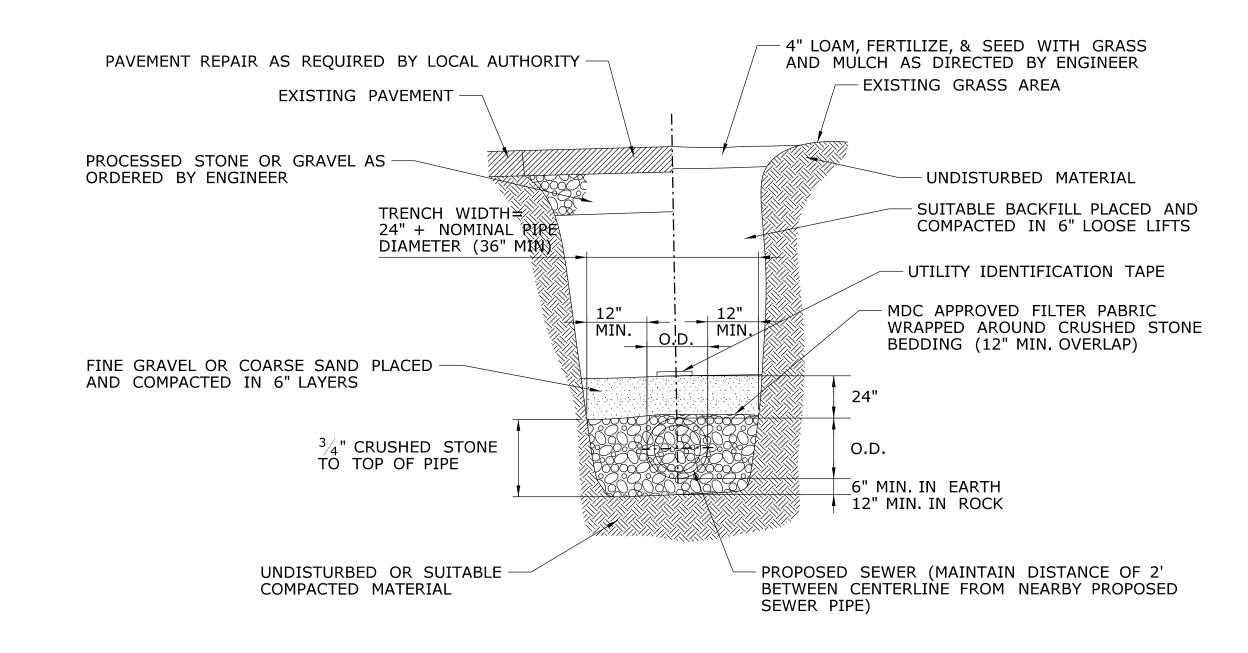

SEWER TRENCH SECTION


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REV.	DATE	REVISION DESCRIPTION	SHEET NO.	Plotted Date: 10/12/2014	

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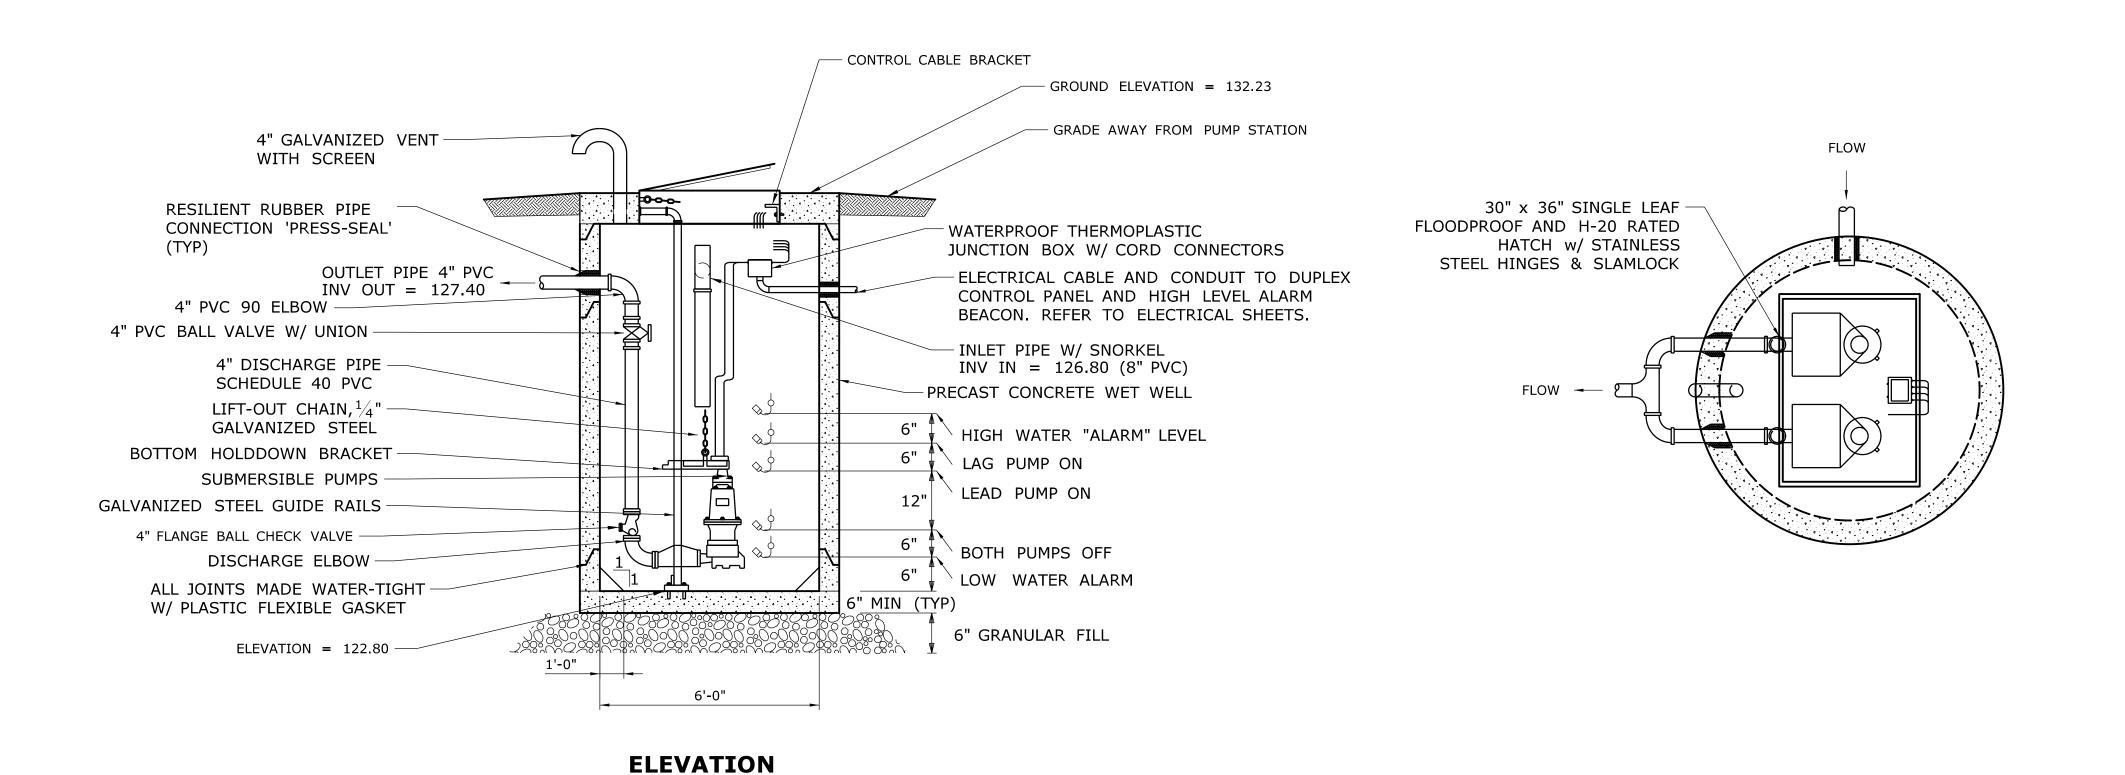


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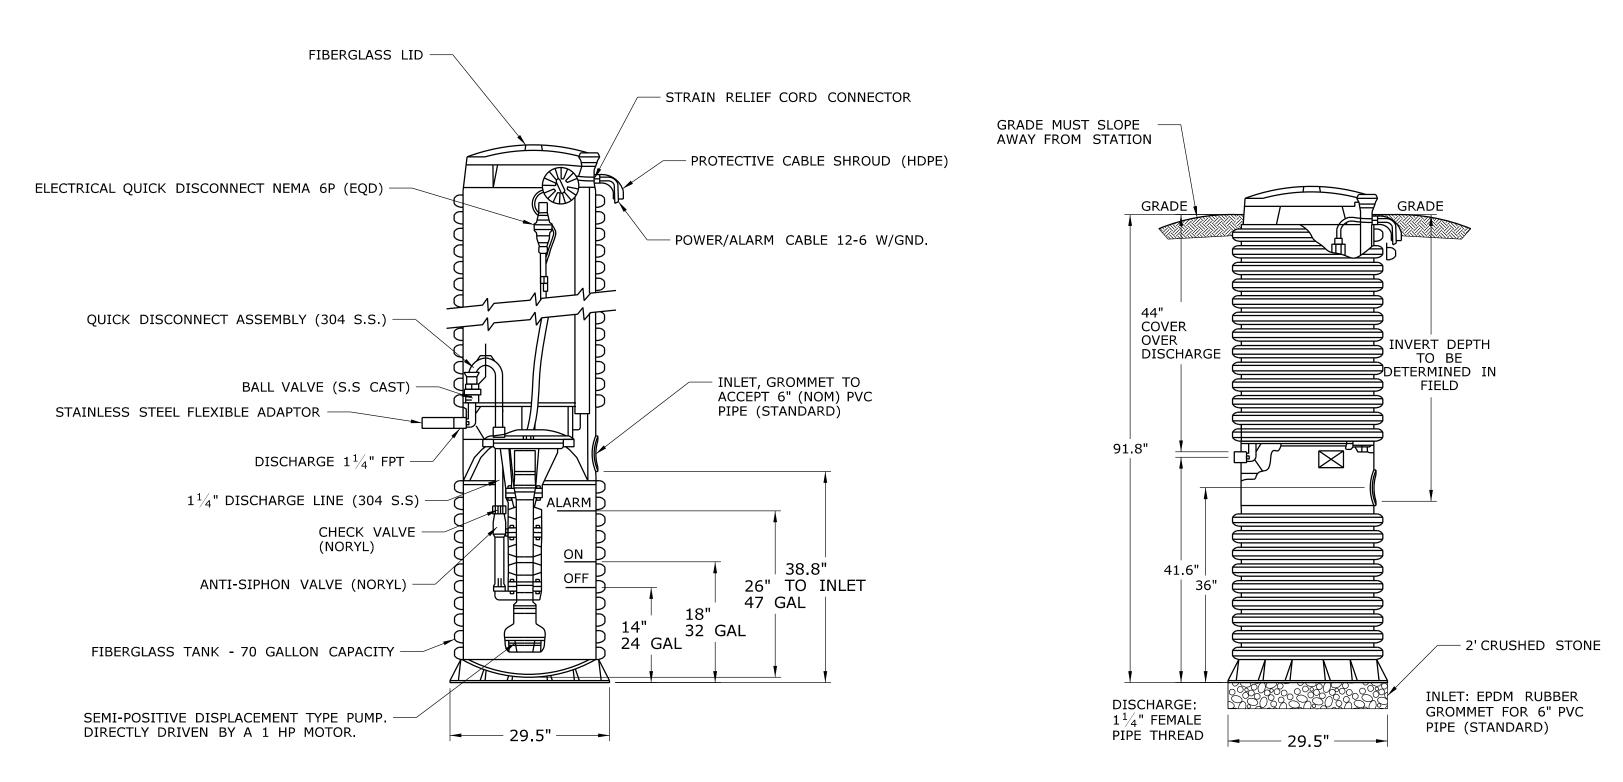
REPAIR	FACLITY

ROCKY HILL	PROJECT NO. 118-167
DRAWING TITLE:	DRAWING NO. C-028
SANITARY SEWER DETAILS - 3	SHEET NO. 05.28

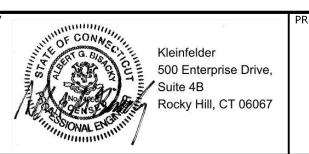


PUMPING STATION (SANITARY SEWER)

NOT TO SCALE




SANITARY PUMP STATION NO. 1


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-	-	GUANTITIES OF WORK, SHOWN ON THESE SHEETS IS BASED ON LIMITED INVESTIGATIONS BY THE STATE AND IS IN NO WAY WARRANTED TO INDICATE	AGB	STATE OF CONNECTICUT	Kleinfelder 500 Enterprise Drive,	REPAIR FACILITY		DRAWING NO. C-029
-	-	THE CONDITIONS OF ACTUAL QUANTITIES OF WORK WHICH WILL BE REQUIRED.	NOT TO SCALE	DEPARTMENT OF TRANSPORTATION	Rocky Hill, CT 06067	KLIAIK TACILITI	SANITARY SEWER	SHEET NO. 05.29
REV	. DATE	REVISION DESCRIPTION SHEET NO. Plotted Date: 10/13/2014		Filename:\FD_MSH_DET_0118_0167_C029.dgn	- Manager		DETAILS - 4	03.29

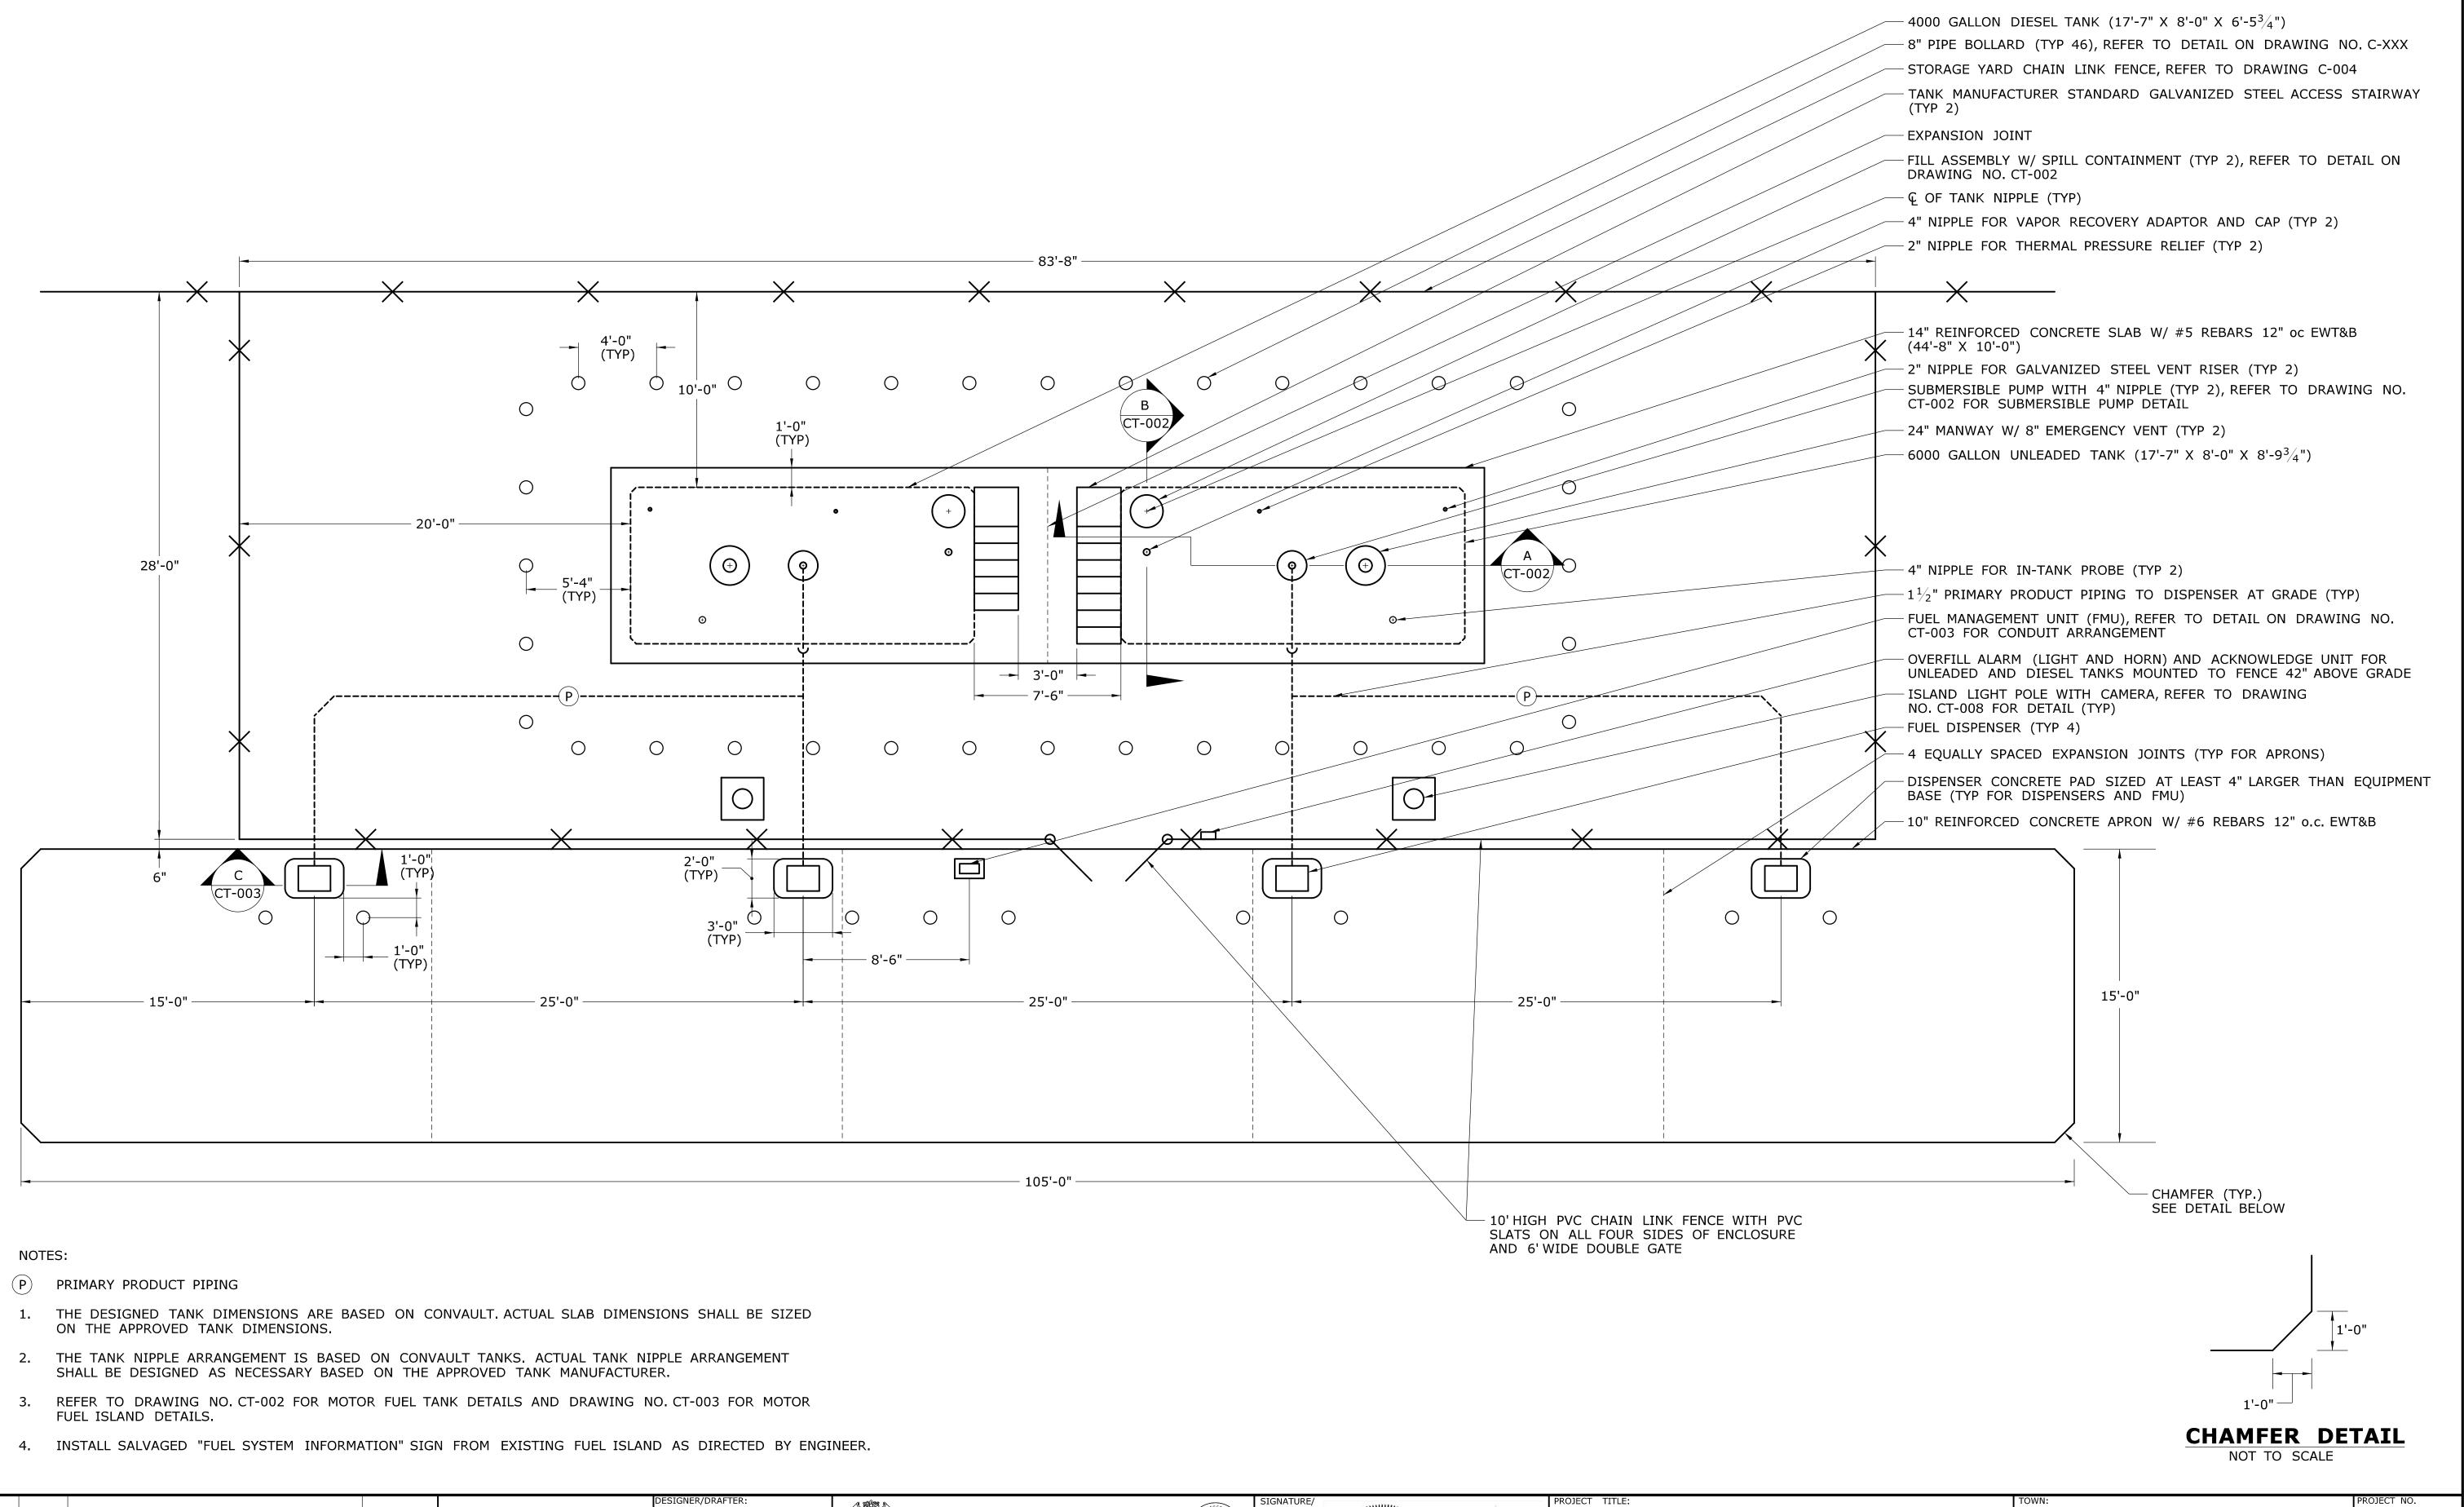


STATE OF CONNECTICUT SAH **ROCKY HILL** 118-167 THE INFORMATION, INCLUDING ESTIMATED QUANTITIES OF WORK, SHOWN ON THESE SHEETS IS BASED ON LIMITED Kleinfelder 500 Enterprise Drive, Suite 4B Rocky Hill, CT 06067 500 Enterprise Drive, INVESTIGATIONS BY THE STATE AND IS IN NO WAY WARRANTED TO INDICATE THE CONDITIONS OF ACTUAL QUANTITIES OF WORK WHICH WILL BE REQUIRED. **AGB** - | - | -REPAIR FACILITY CT-001 **DEPARTMENT OF TRANSPORTATION** MOTOR FUEL ISLAND SCALE: $\frac{1}{4}$ " = 1'-0" 05.30 **PLAN** REV. DATE REVISION DESCRIPTION SHEET NO. Plotted Date: 10/11/2014 Filename: ...\FD_MSH_CIV_0118_0167_CT001.dgn

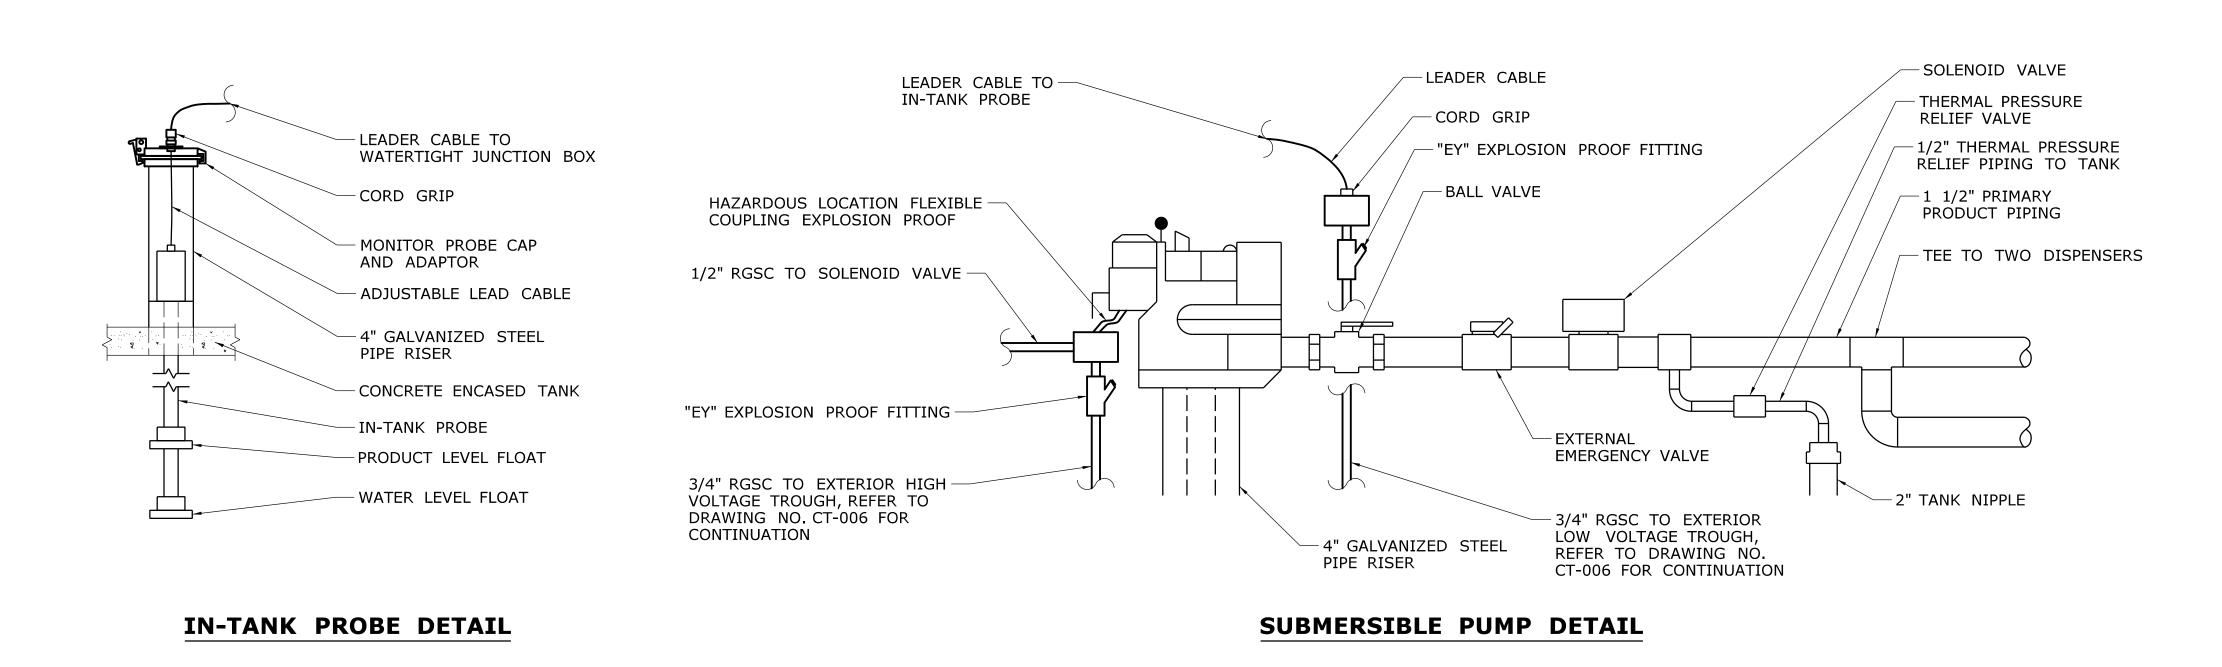

- THE DESIGNED TANK DIMENSIONS ARE BASED ON CONVAULT. ACTUAL SLAB DIMENSIONS SHALL BE SIZED BASED ON THE APPROVED TANK DIMENSIONS.
- 2. THE TANK NIPPLE ARRANGEMENT IS BASED ON CONVAULT TANKS.
 ACTUAL TANK NIPPLE ARRANGEMENT SHALL BE DESIGNED AS NECESSARY
 BASED ON THE APPROVED TANK MANUFACTURER.
- 3. ALL CONDUITS SHALL BE PROVIDED WITH EXPLOSION PROOF FITTINGS AND SEALED AS REQUIRED IN ACCORDANCE WITH NFPA 70.

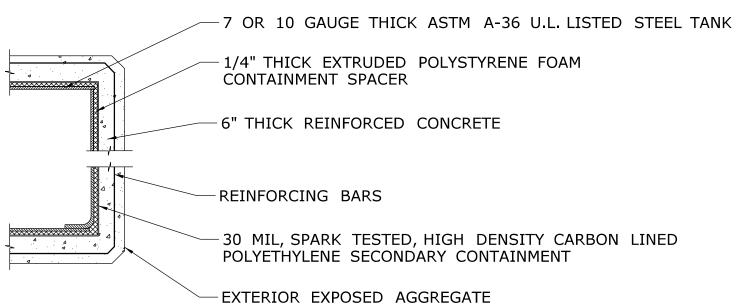


TANK DETAILS

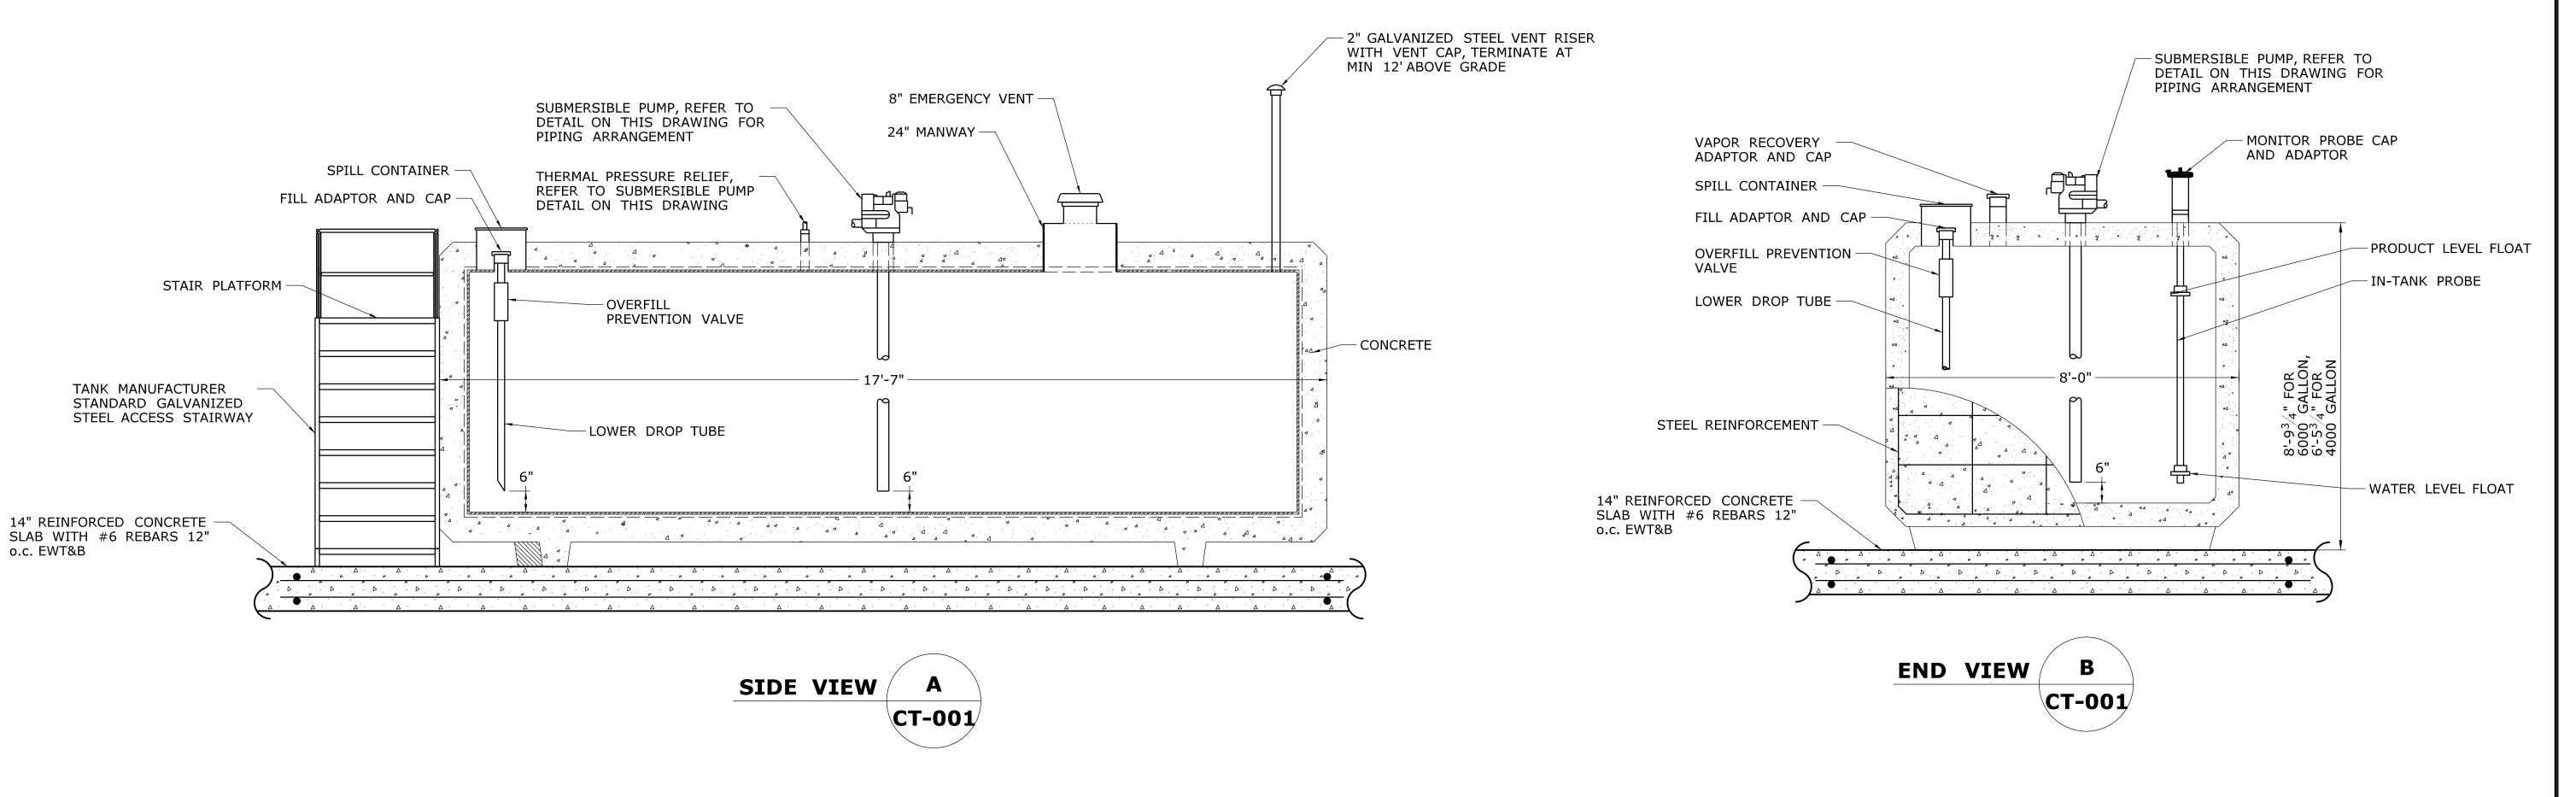


MOTOR FUEL ABOVEGROUND STORAGE TANK DETAIL

-	-	-	-	THE INFORMATION, INCLUDING ESTIMATED QUANTITIES OF WORK, SHOWN ON THESE	DESIGNER/DRAFTER: SAH CHECKED BY:	SIGN BLOCK	NATURE/ CK: Kleinfelder 500 Enterprise Drive.	OJECT TITLE:	ROCKY HILL	PROJECT NO. 118-167
-	-	-	-	INVESTIGATIONS BY THE STATE AND IS IN NO WAY WARRANTED TO INDICATE THE CONDITIONS OF ACTUAL QUANTITIES	AGB	DEPARTMENT OF TRANSPORTATION	500 Enterprise Drive, Suite 4B Rocky Hill CT 06067	REPAIR FACILITY	DRAWING TITLE:	CT-002
- - REV.	- - DATE	- REVISION DESCRIPTION S	- HEET NO	OF WORK WHICH WILL BE REQUIRED. Plotted Date: 10/11/2014	NOT TO SCALE	Filename:\FD_MSH_CIV_0118_0167_CT002.dgn	A CONSTITUTION OF COORS		MOTOR FUEL TANK DETAILS	05.31

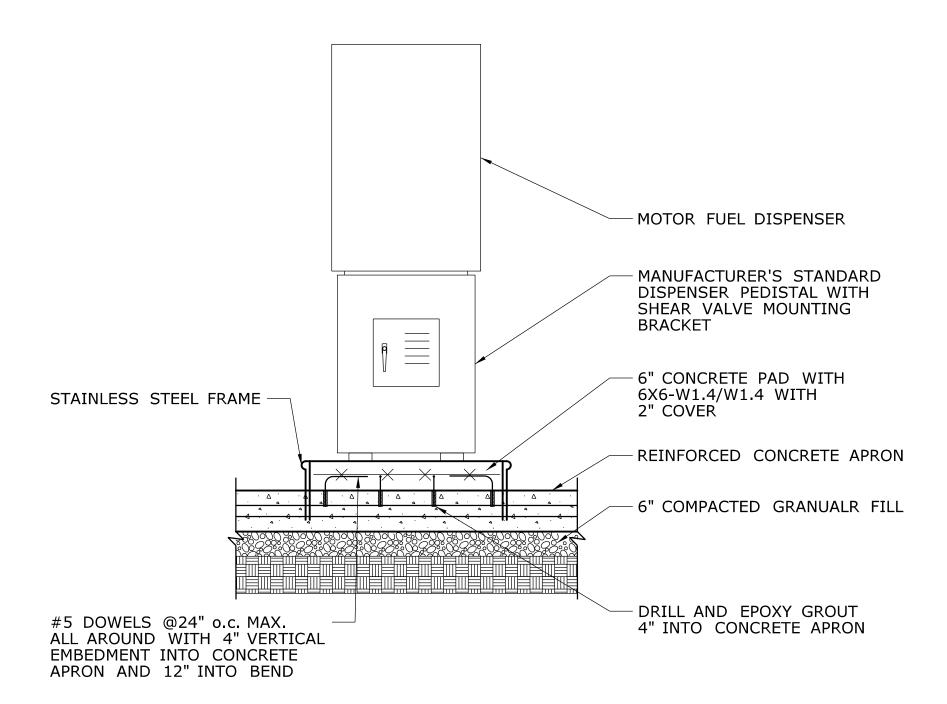




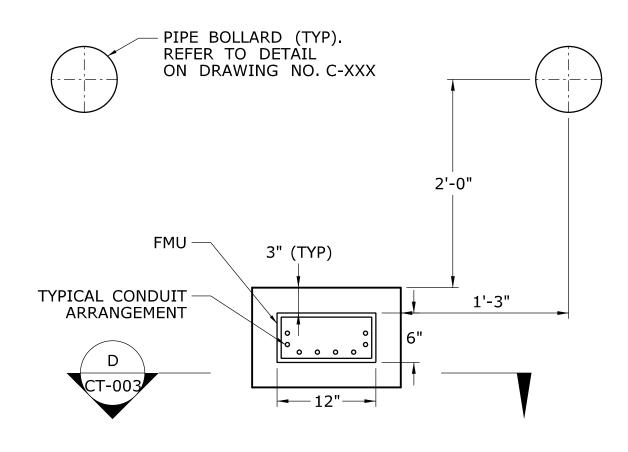


FUEL MANAGEMENT UNIT (FMU) SETTING DETAIL

NOTES:


1. FMU SHALL BE SECURED TO CONCRETE WITH STAINLESS STEEL HARDWARE. SEAL BASE OF FMU TO CONCRETE WITH SILICONE TO FORM A WATERTIGHT SEAL.

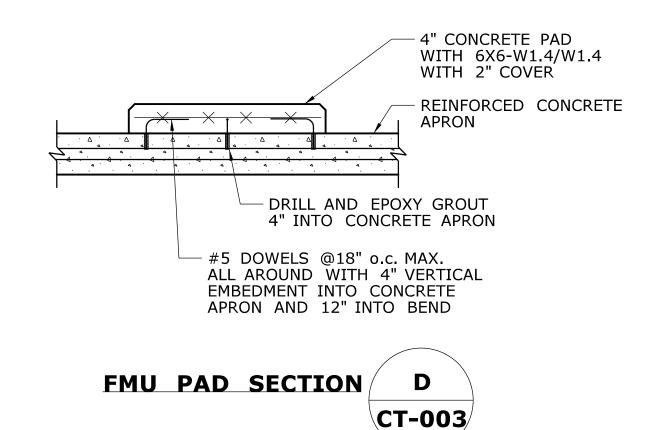

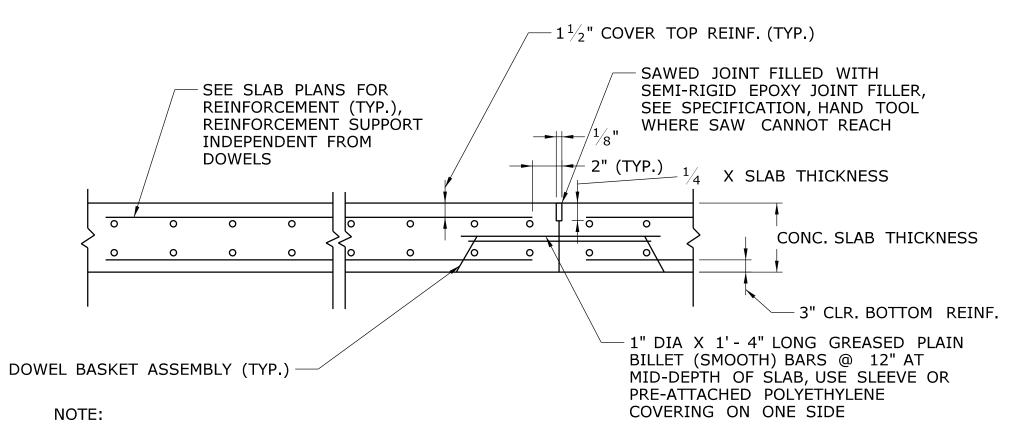

1. AT CONTRACTOR'S OPTION - CONTROL JOINTS MAY BE FORMED OR SAWED. JOINTS SHALL BE SAWCUT WITHIN 8 HOURS AFTER CONCRETE HAS BEEN PLACED.

CONTROL JOINT

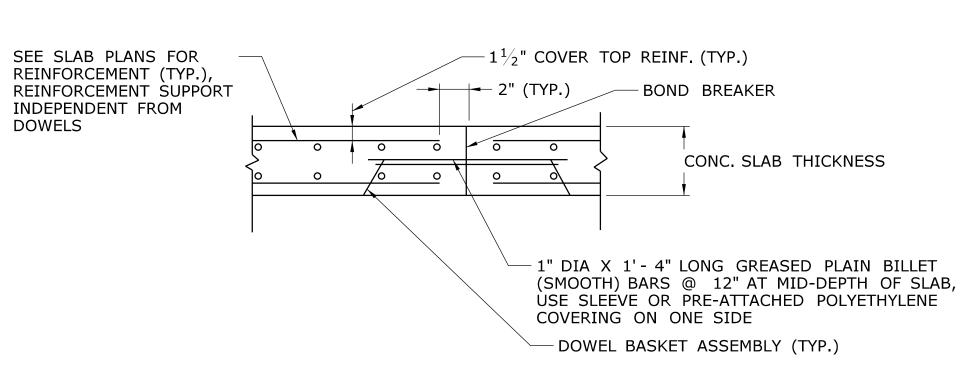

CONSTRUCTION JOINT

SLAB ON GRADE DETAILS

NOT TO SCALE

-	-	-	1	THE INFORMATION, INCLUDING ESTIMATED
-	-	-	ı	QUANTITIES OF WORK, SHOWN ON THESE SHEETS IS BASED ON LIMITED
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SHEET NO. Plotted Date: 10/13/2014

REVISION DESCRIPTION


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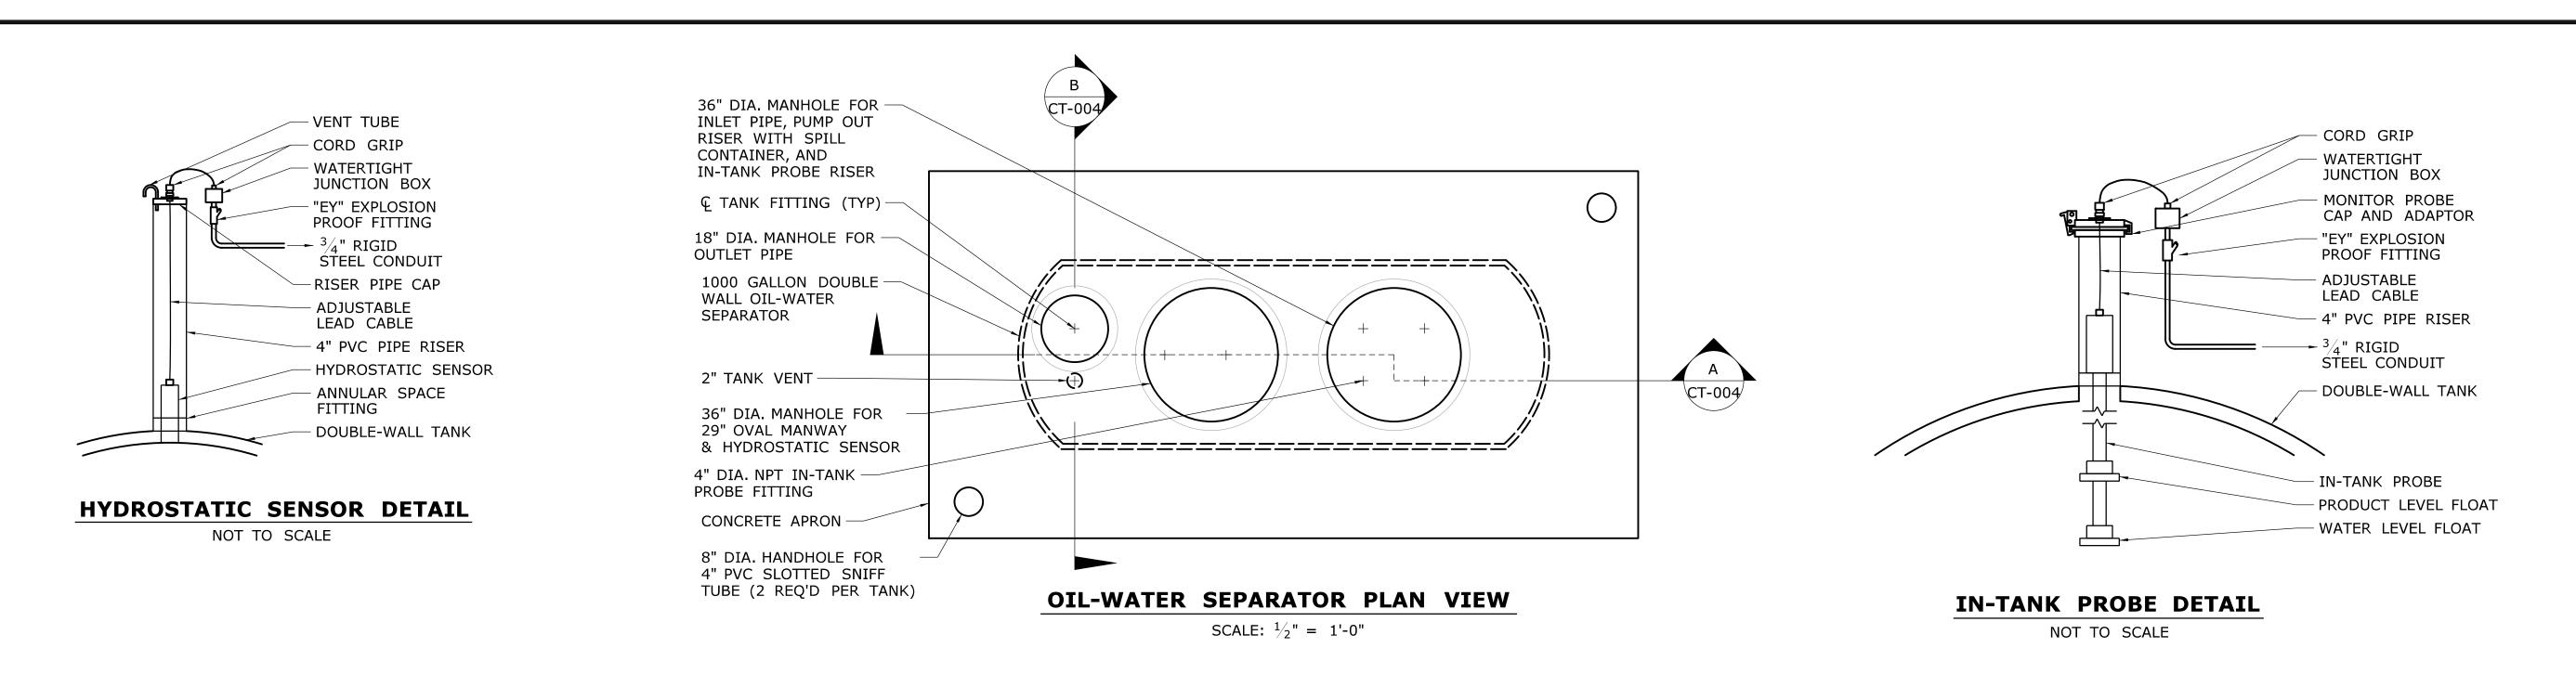
STATE OF CONNECTICUT **DEPARTMENT OF TRANSPORTATION**


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REPAIR FACILITY

ROCKY HILL 118-167 RAWING NO. CT-003 MOTOR FUEL ISLAND 05.32 **DETAILS**




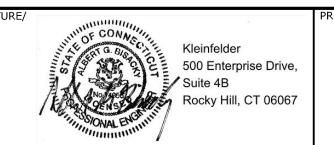



- 1. THE DESIGNED TANK DIMENSIONS ARE BASED ON CONTAINMENT SOLUTIONS. ACTUAL PAD DIMENSIONS SHALL BE SIZED BASED ON THE APPROVED TANK DIMENSIONS.
- 2. THE MANHOLE ARRANGEMENT IS BASED ON CONTAINMENT SOLUTIONS TANKS. ACTUAL MANHOLE ARRANGEMENT SHALL BE REDESIGNED AS NECESSARY BASED ON THE APPROVED TANK MANUFACTURER.
- 3. ALL CONDUITS SHALL BE PROVIDED WITH EXPLOSIONPROOF FITTINGS AND SEALED AS REQUIRED IN ACCORDANCE WITH NFPA 70.
- 4. ALLOW SLACK AT TANK IN ALL PIPING FOR SETTLING OF TANK.

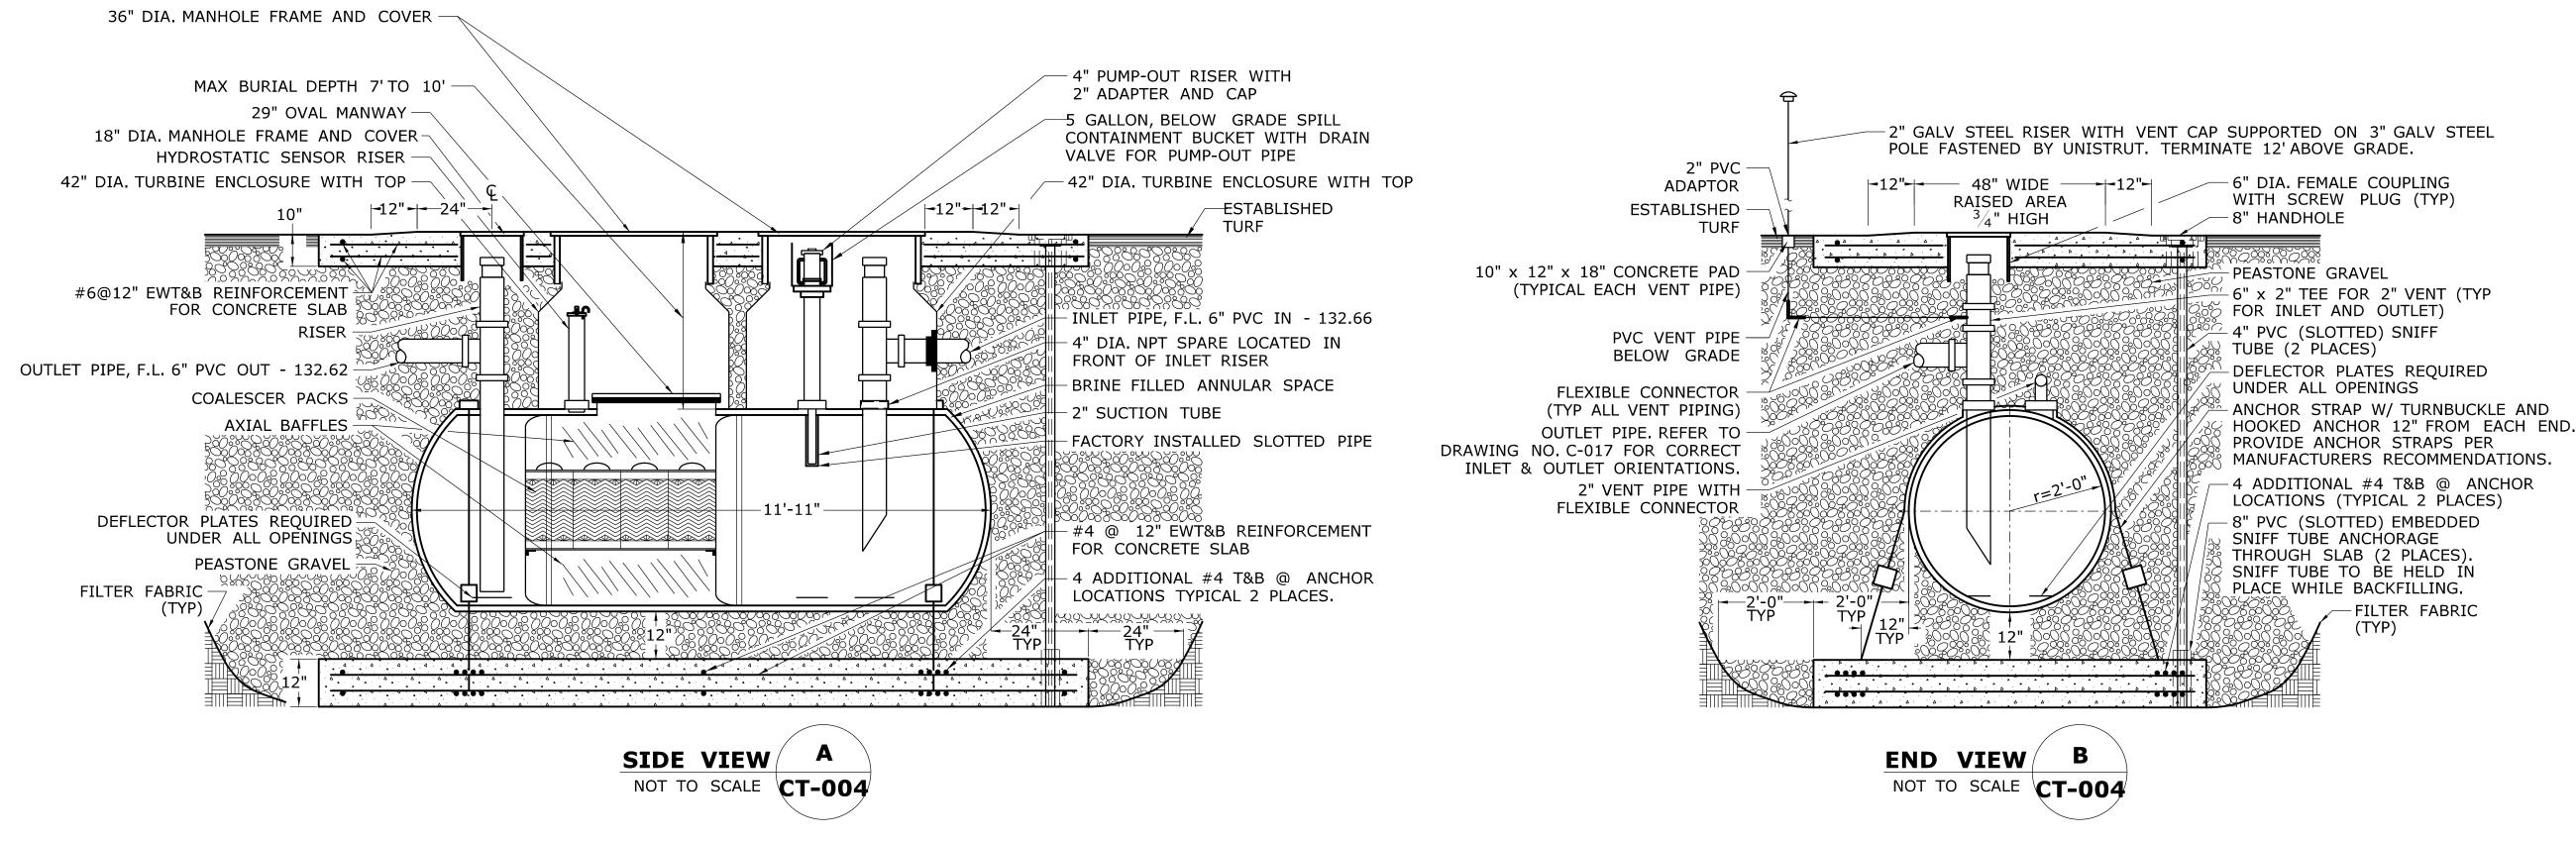
1000 GALLON DOUBLE WALL OIL-WATER SEPARATOR DETAIL


THE INFORMATION, INCLUDING ESTIMATED OUANTITIES OF WORK SHOWN ON THESE	SIGN BLO	GNATURE/ OCK: Kleinfelder	PROJECT TITLE:	ROCKY HILL	PROJECT NO. 118-167
SHEETS IS BASED ON LIMITED INVESTIGATIONS BY THE STATE AND IS IN NO WAY WARRANTED TO INDICATE THE CONDITIONS OF ACTUAL QUANTITIES CHECKED BY: AGB AGB	STATE OF CONNECTICUT DEPARTMENT OF TRANSPORTATION	500 Enterprise Drive, Suite 4B	REPAIR FACILITY	DRAWING TITLE:	DRAWING NO. CT-004
 OF WORK WHICH WILL BE REQUIRED. SCALE AS NOTED	DEPARTMENT OF TRANSPORTATION Filename: VED MSH CIV 0118 0167 CT004 dgp	Rocky Hill, CT 06067		OIL-WATER SEPARATOR	SHEET NO. 05.33

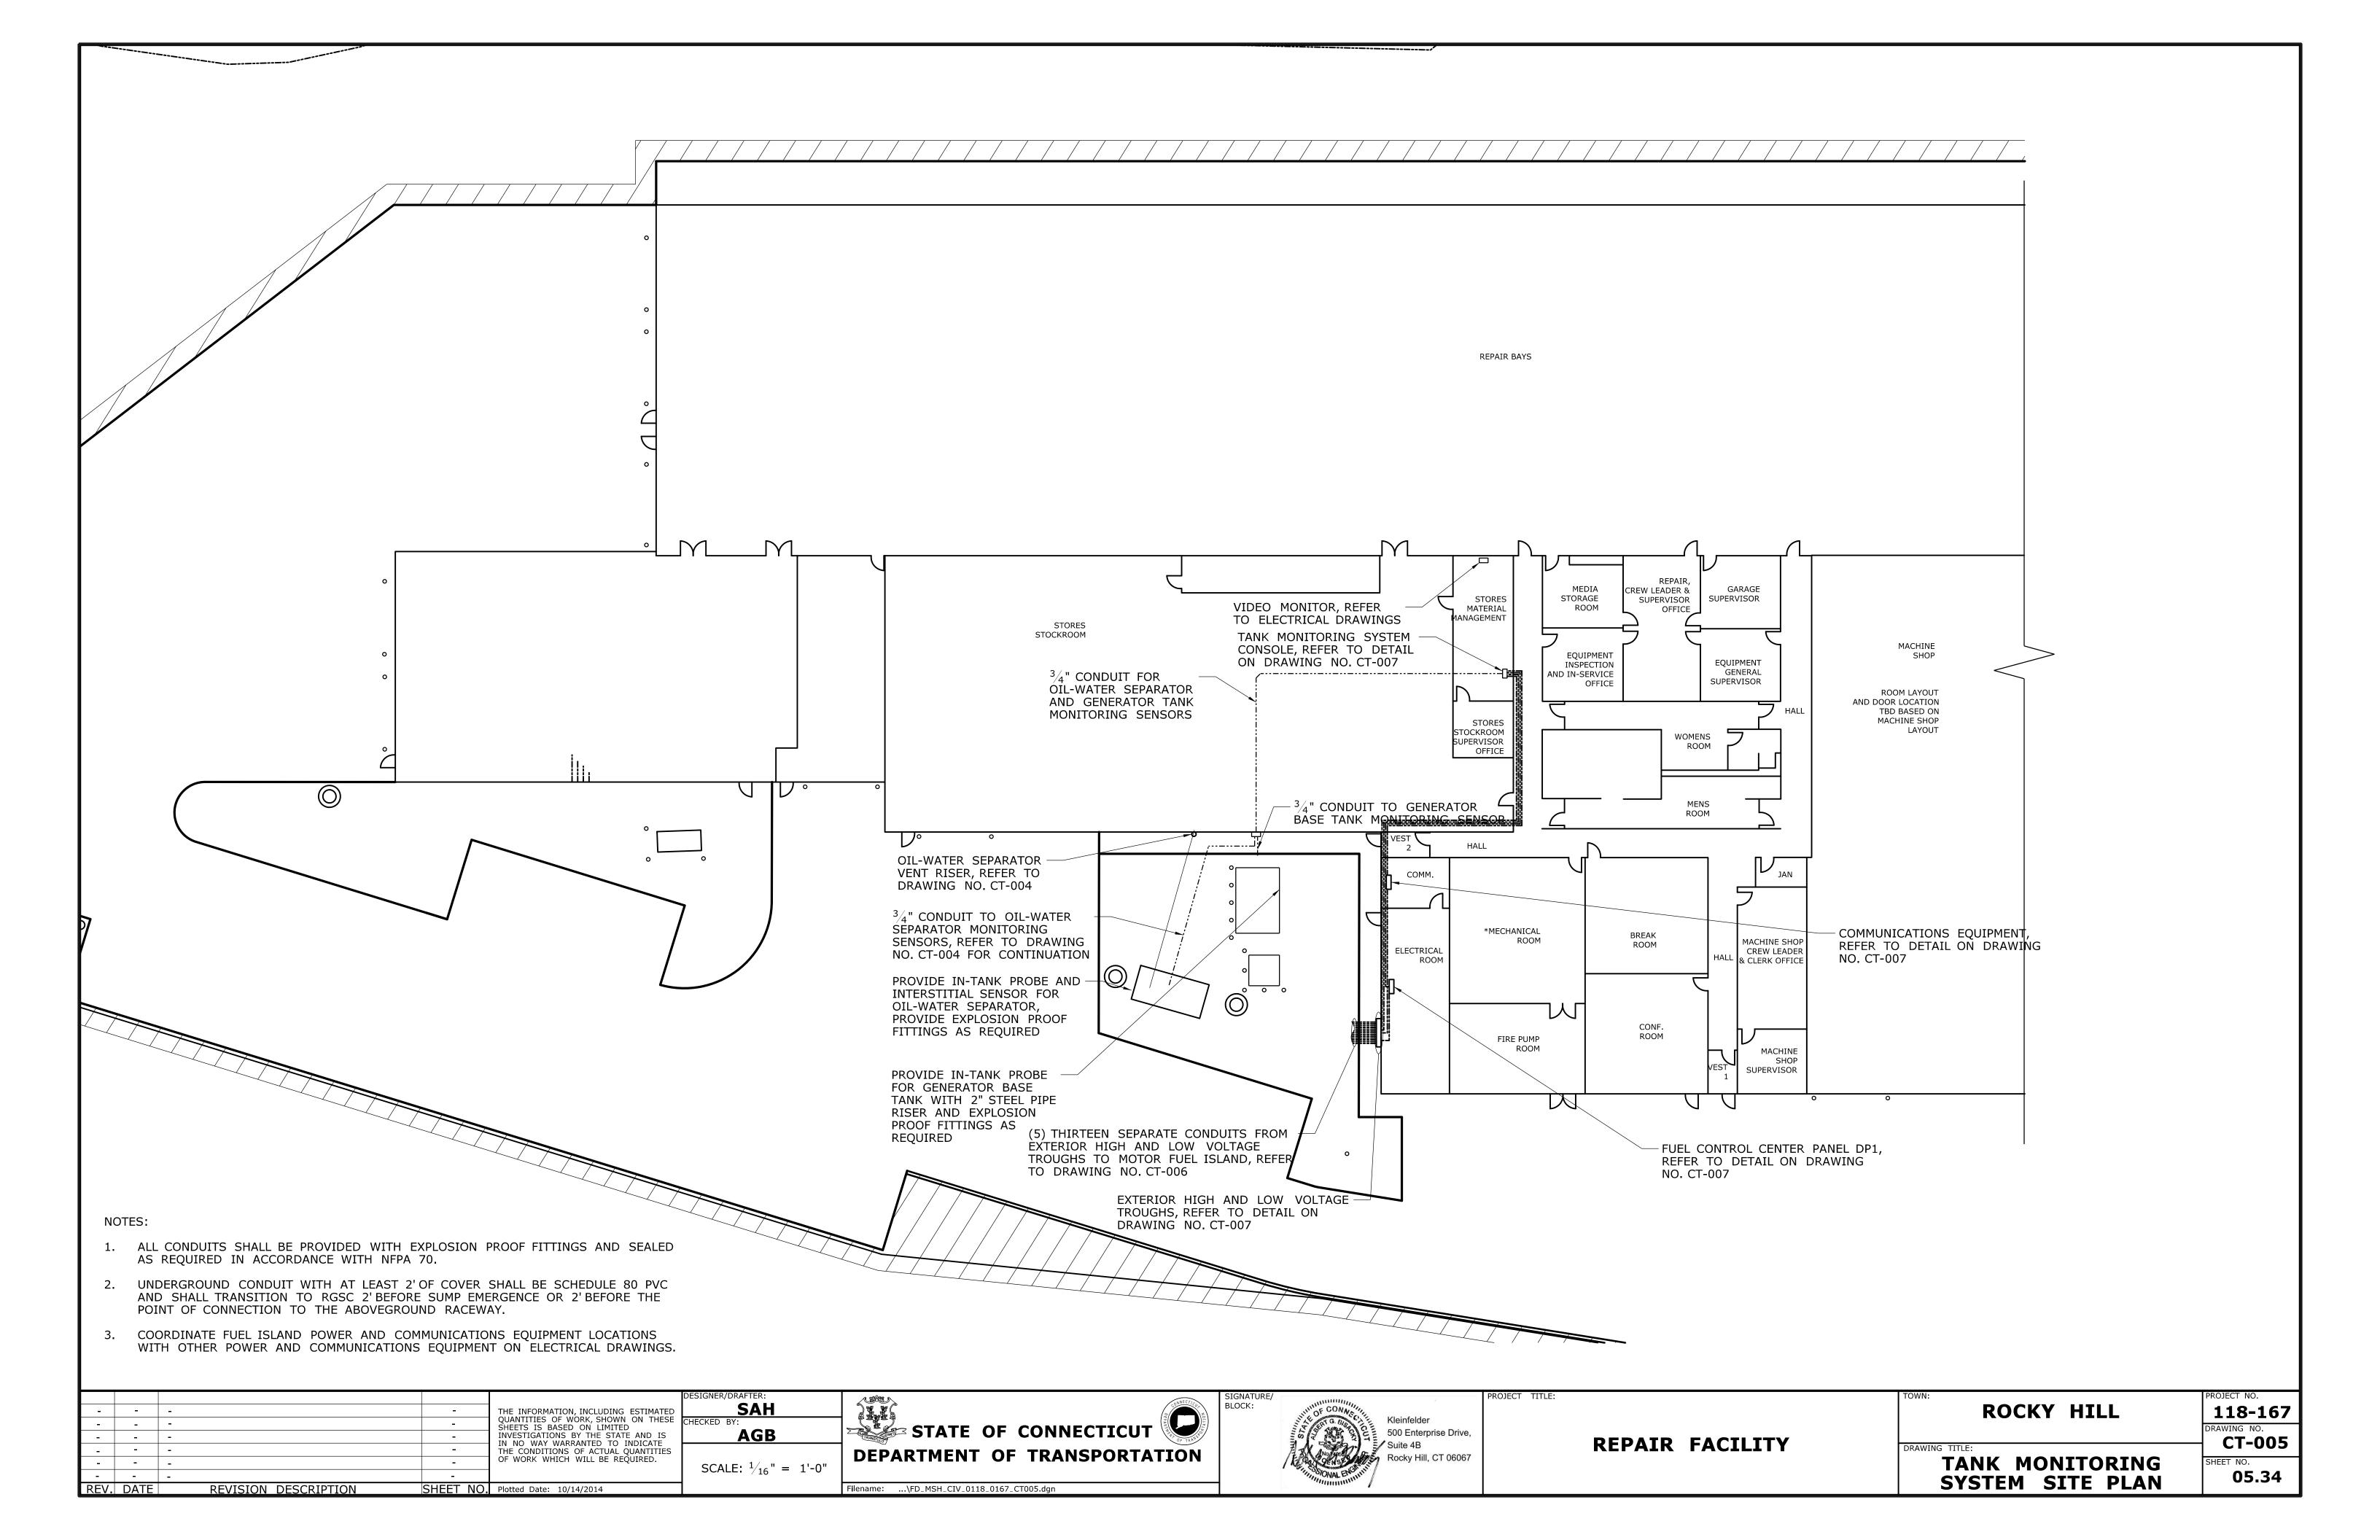


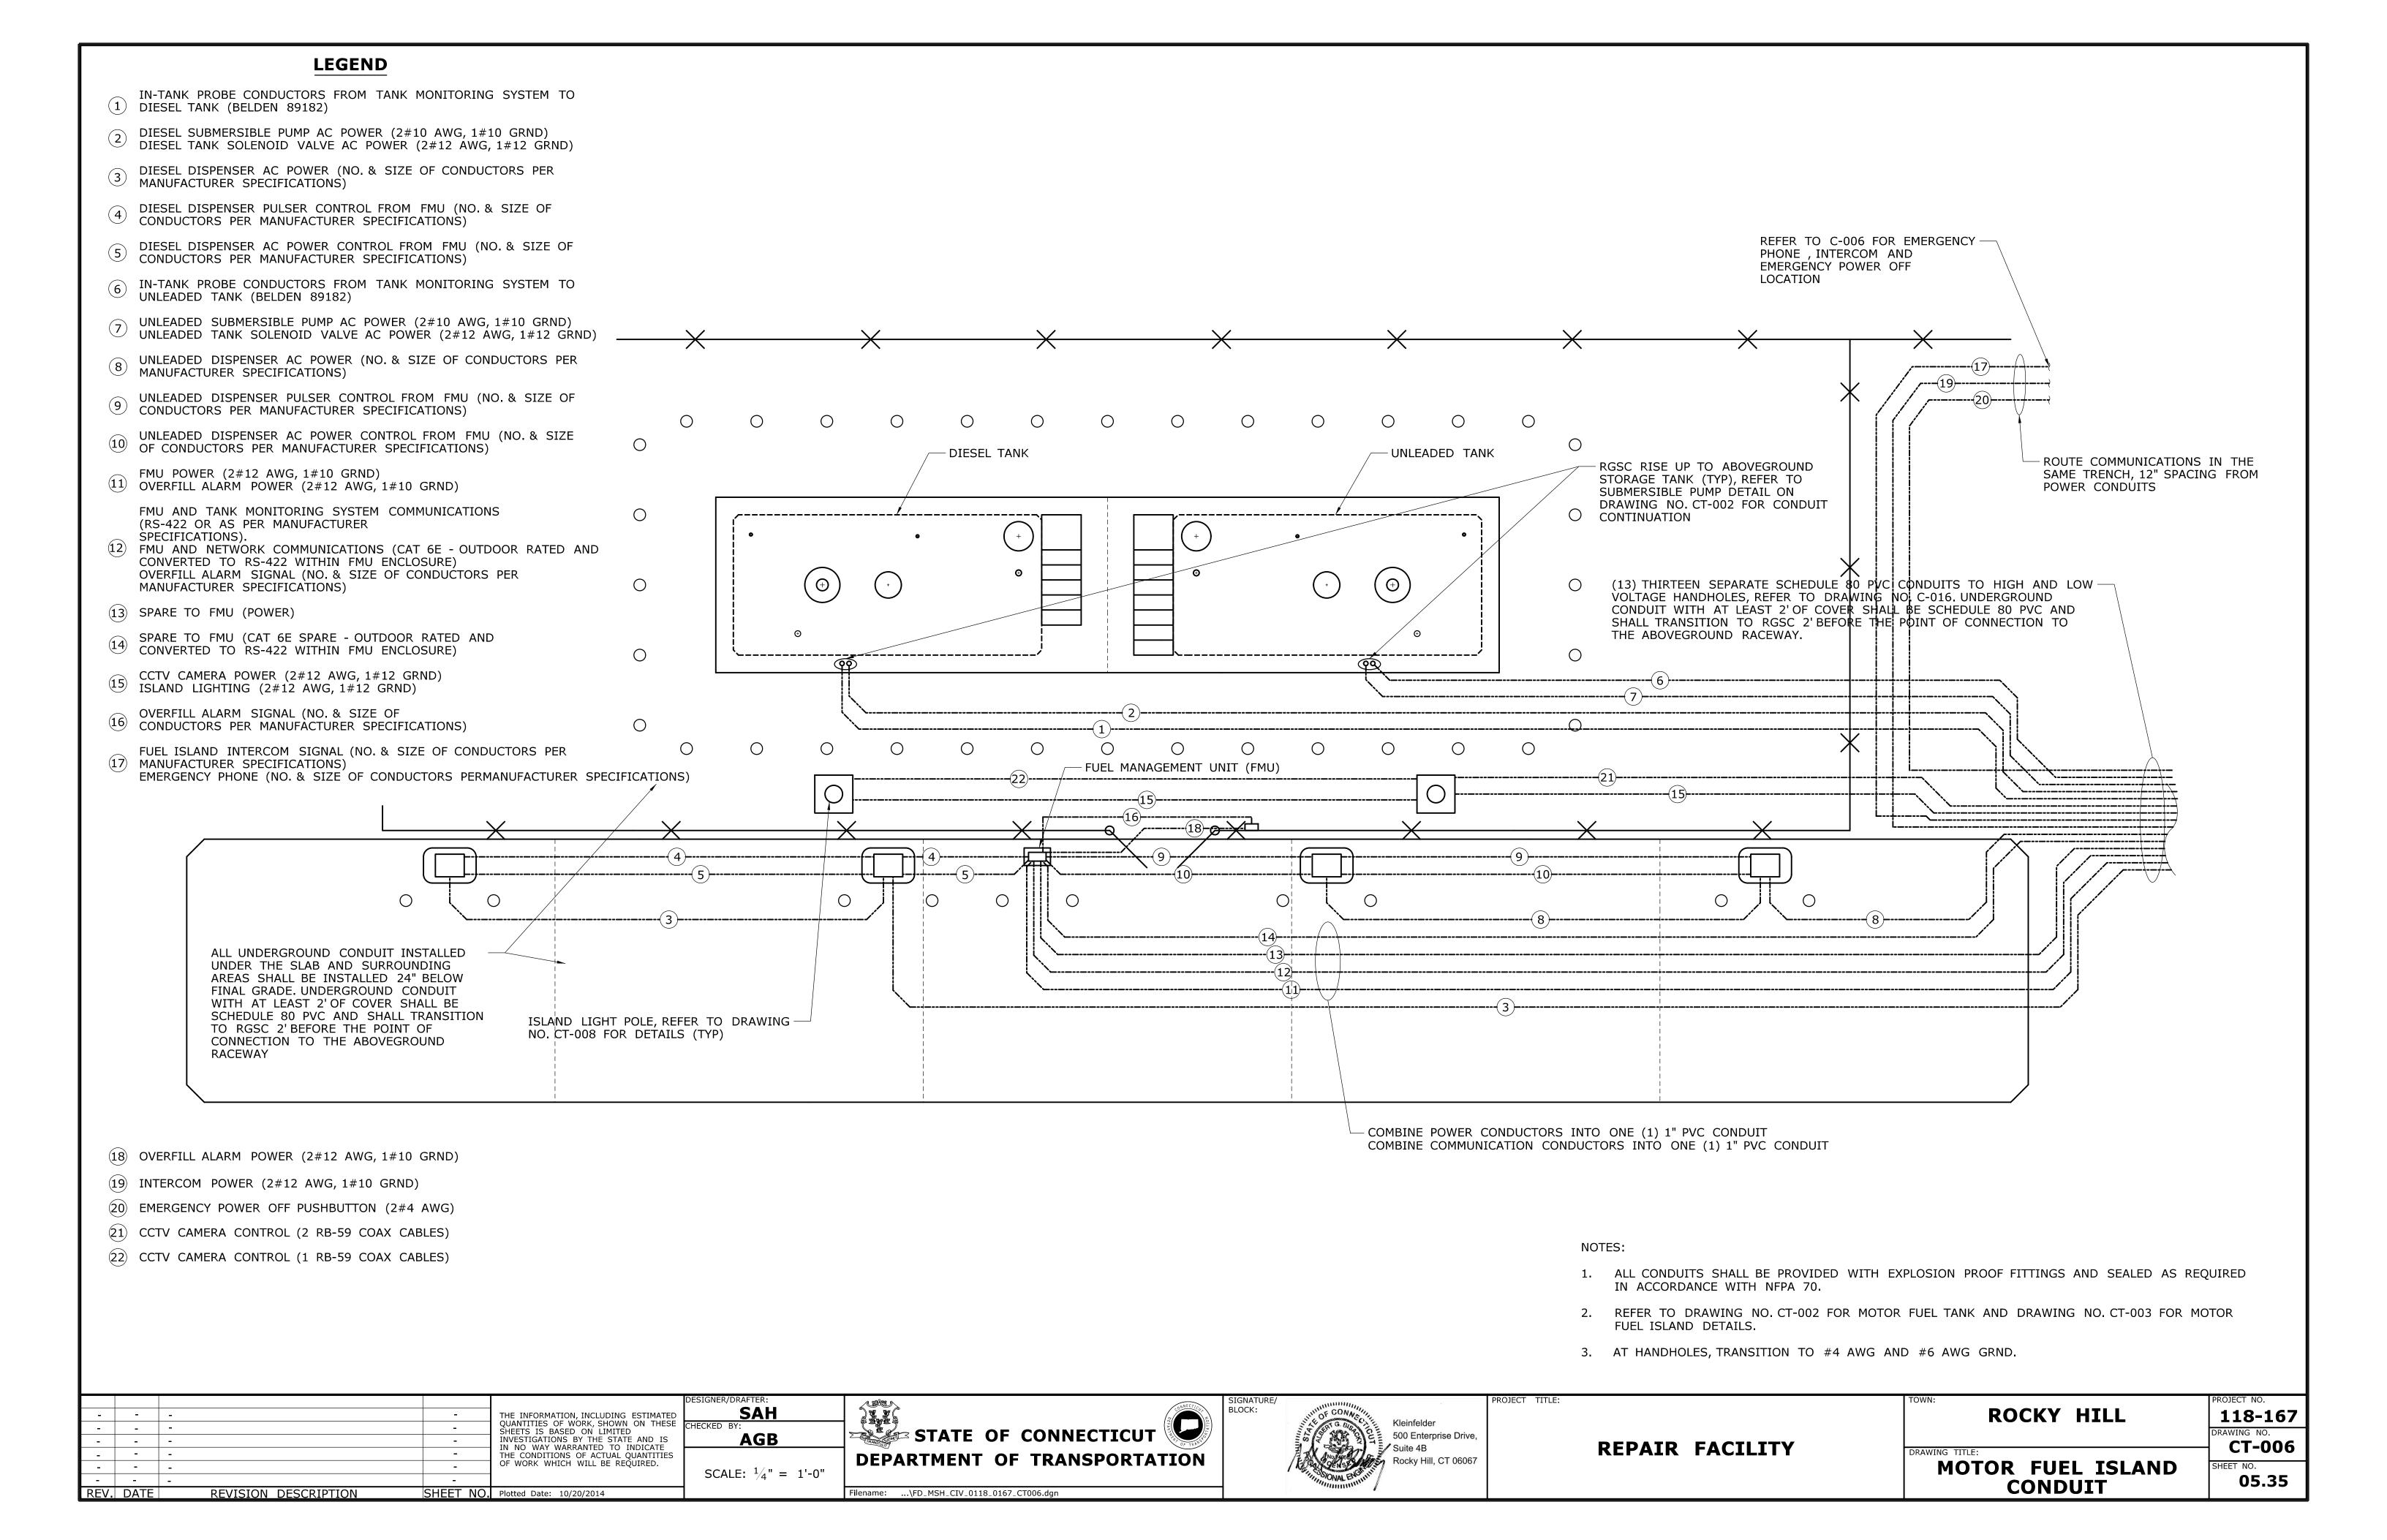

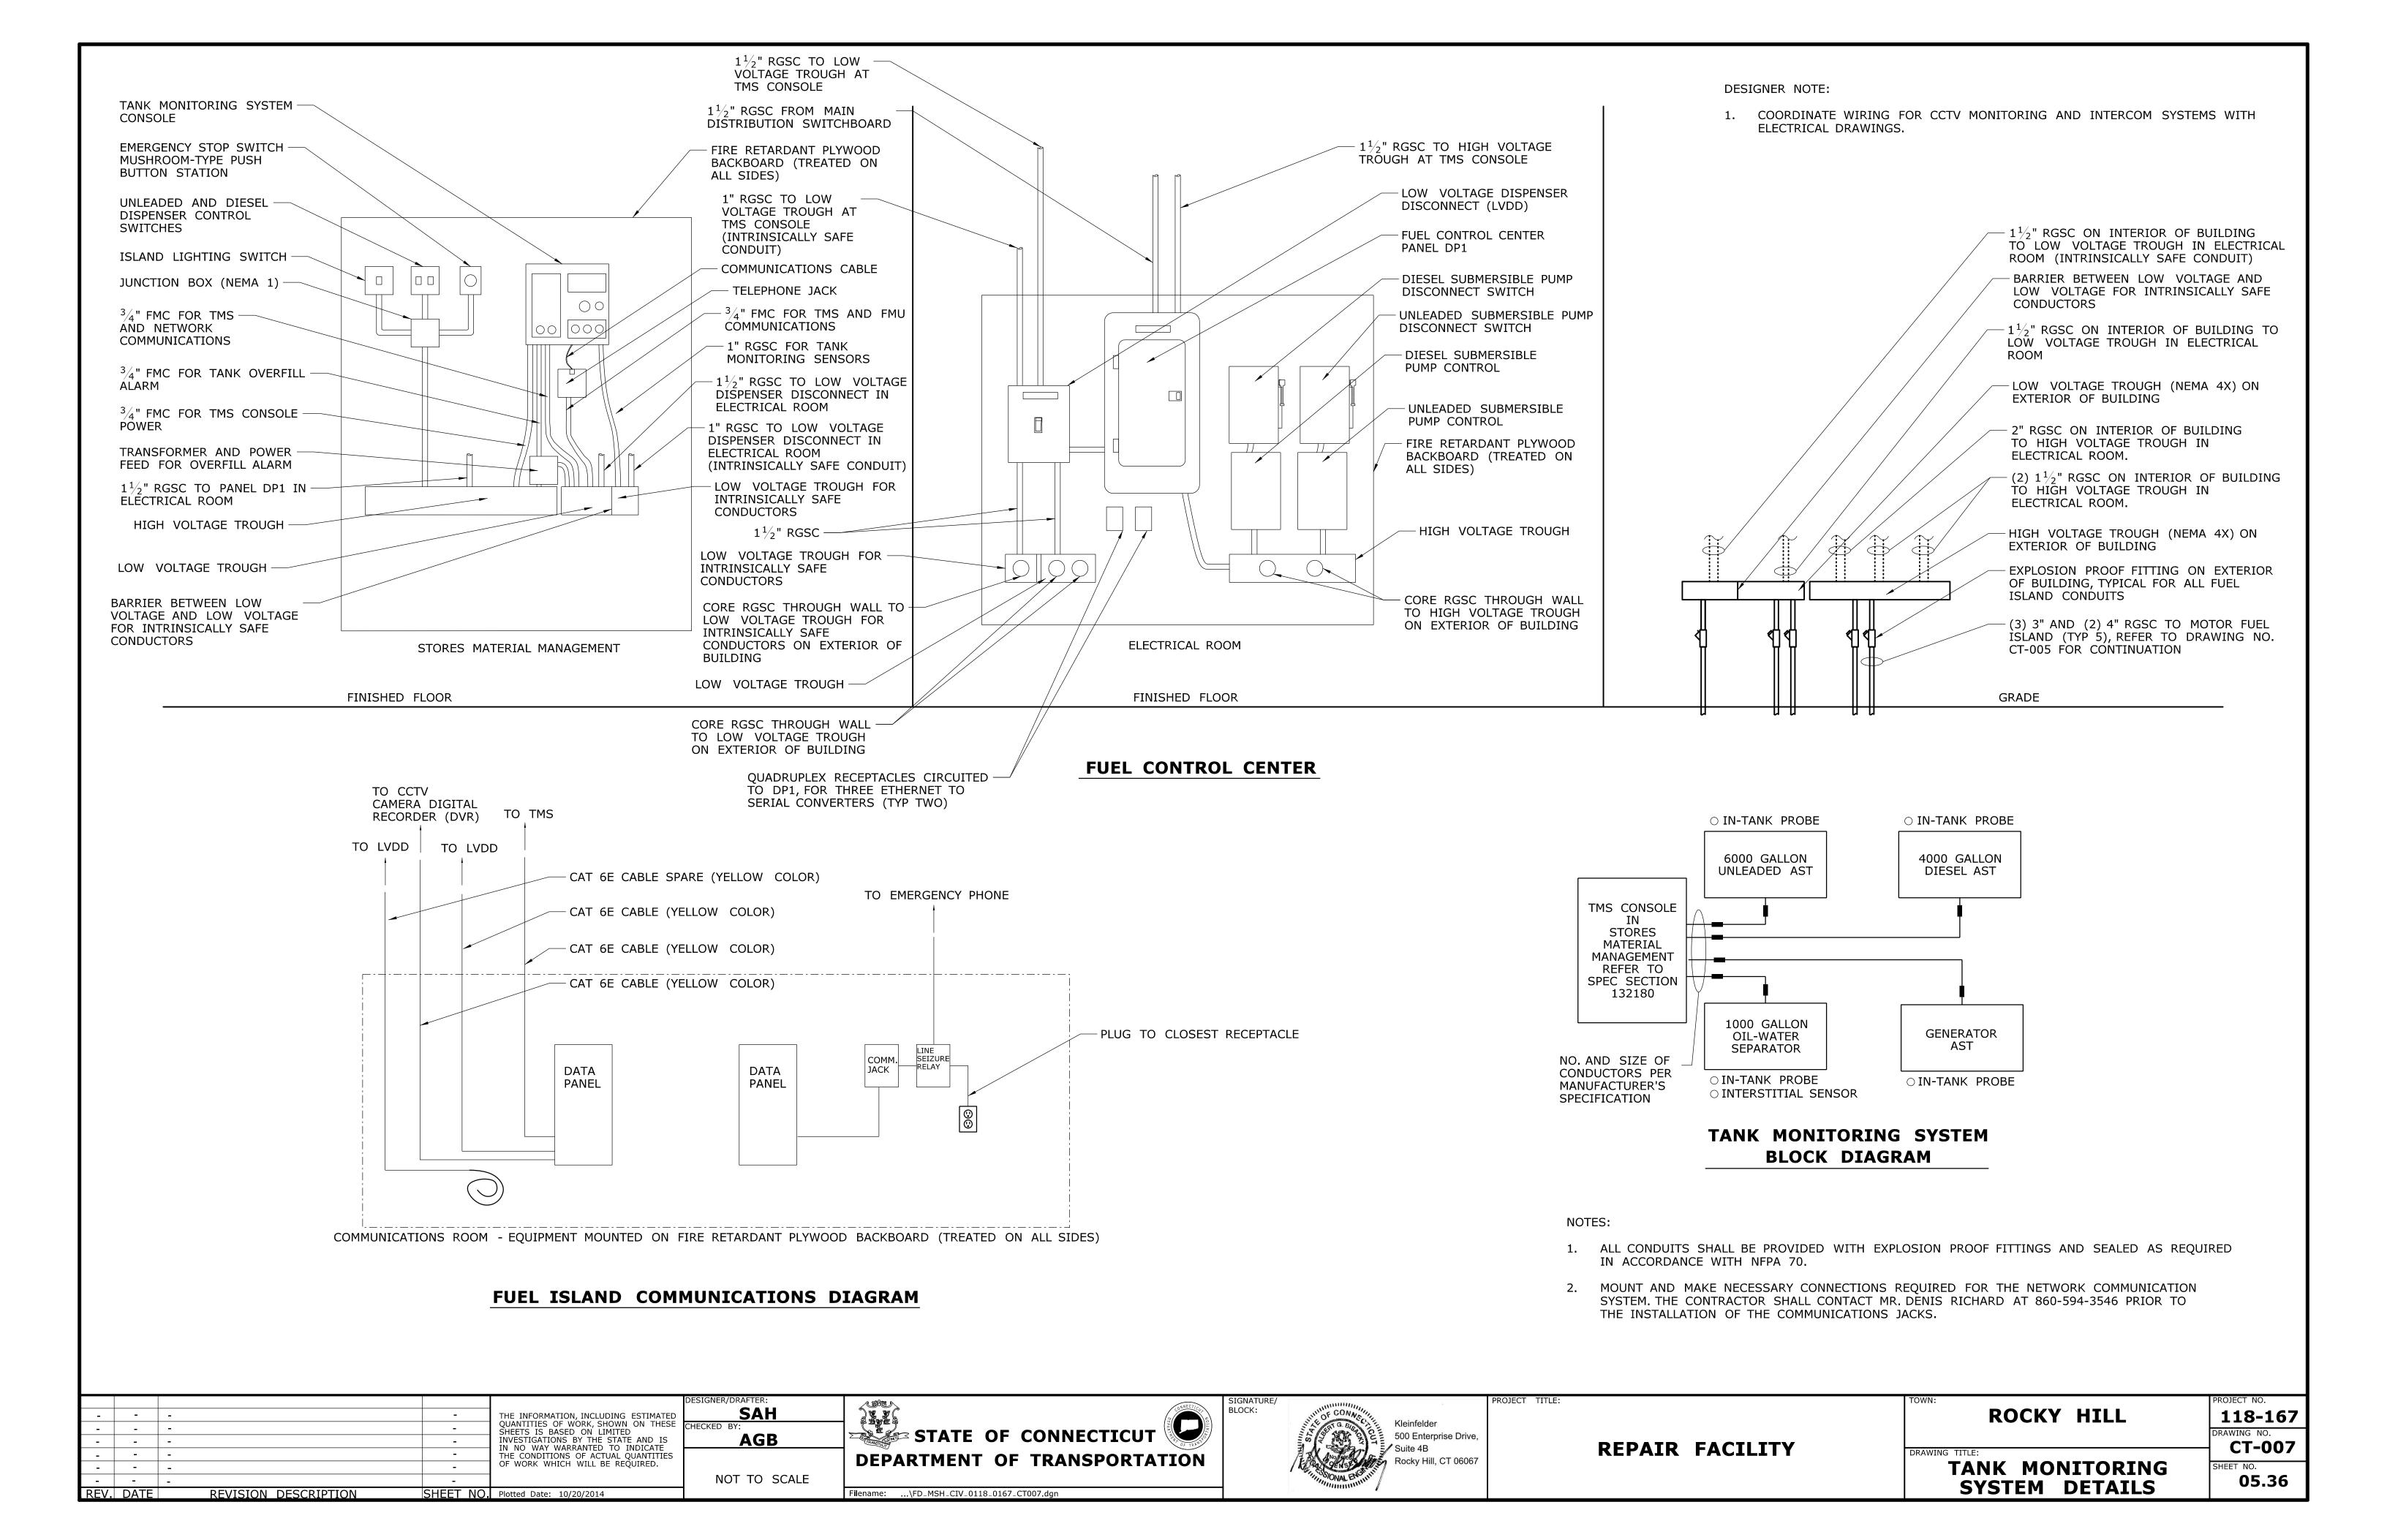

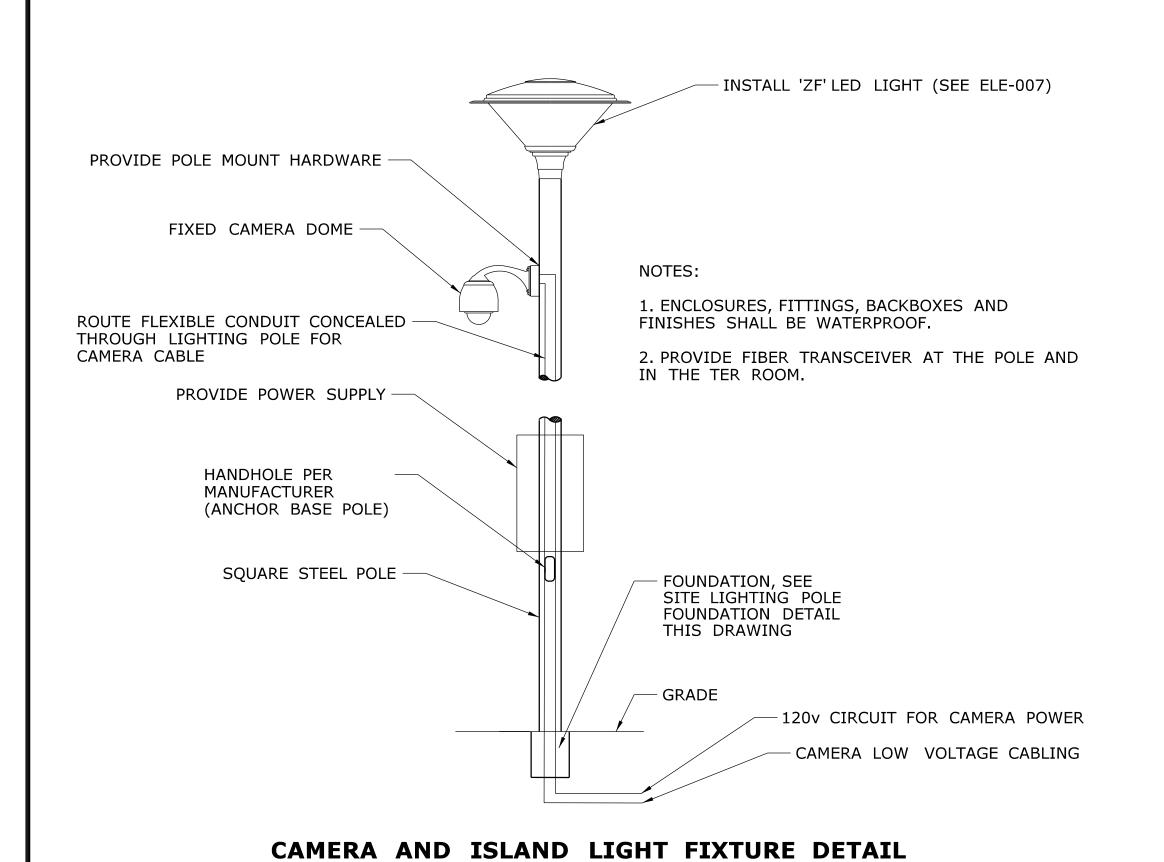


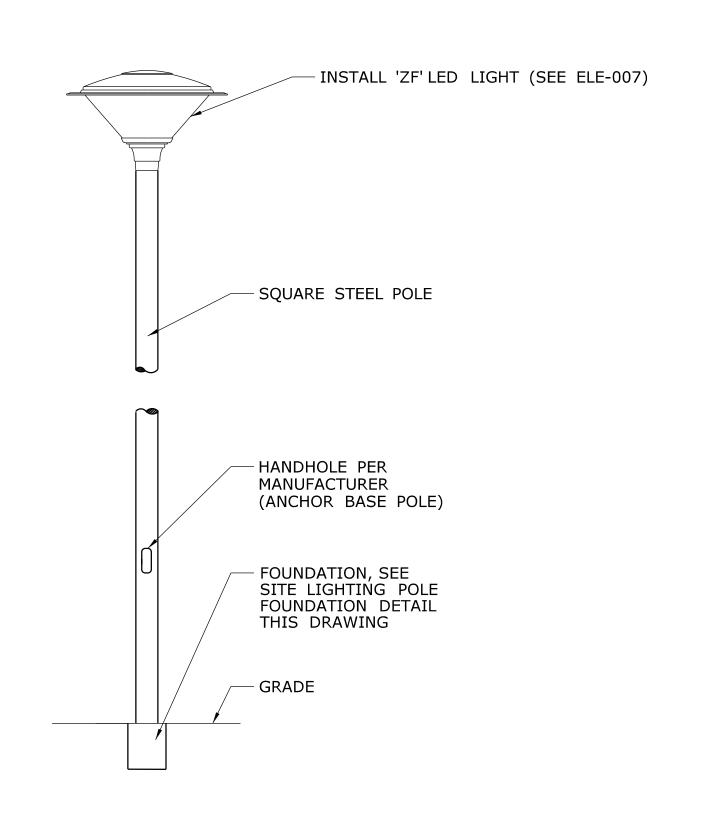


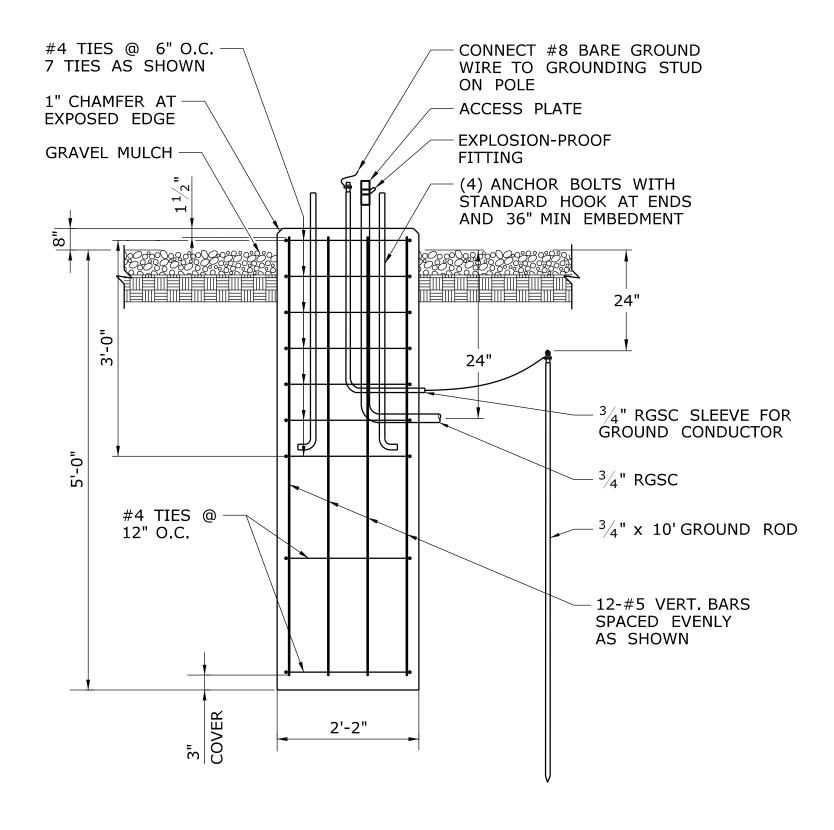

ISLAND LIGHT FIXTURE DETAIL




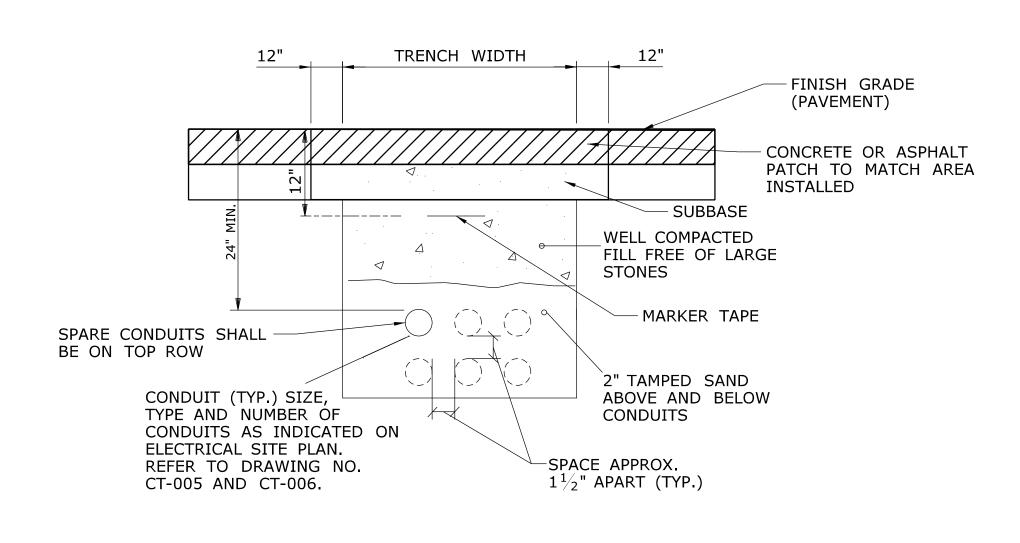

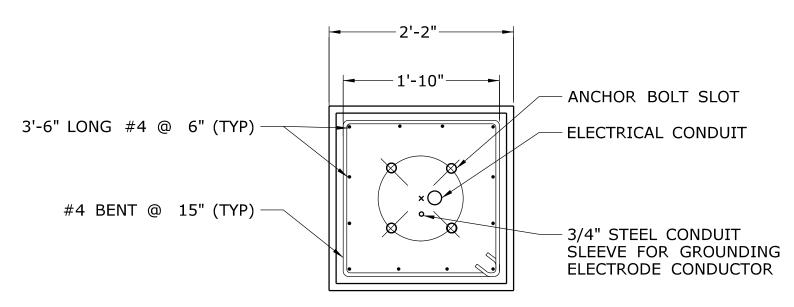

NOTE: FACTORY SUPPLIED TEMPLATES MUST BE USED WHEN SETTING ANCHOR BOLTS, FIELD VERIFY DIMENSIONS BEFORE CONSTRUCTION.

ISLAND LIGHT POLE BASE PLATE

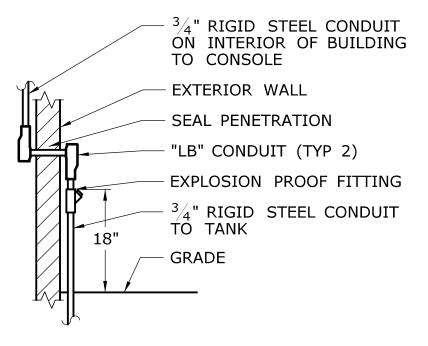


TANK MONITORING SYSTEM
TYPICAL CONDUIT DROP DETAIL

CONDUIT	TRENCH	DETAIL
-		

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-	-	-	-	THE INFORMATION, INCLUDING ESTIMATED	
-	-	-	-	QUANTITIES OF WORK, SHOWN ON THESE SHEETS IS BASED ON LIMITED INVESTIGATIONS BY THE STATE AND IS IN NO WAY WARRANTED TO INDICATE THE CONDITIONS OF ACTUAL QUANTITIES	Cŀ
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REV.	DATE	REVISION DESCRIPTION	SHEET NO.	Plotted Date: 10/11/2014	





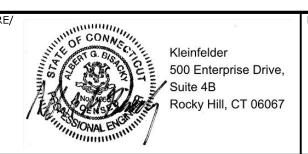

REPAIR	FACILITY

DWN:	PROJECT NO.
ROCKY HILL	118-167
RAWING TITLE:	DRAWING NO. CT-008
MOTOR FUEL ISLAND ELECTRICAL DETAILS	SHEET NO. 05.37